MICHIGAN SPECIFICATIONS FOR CONSTRUCTION. ROAD SHEET DEPARTMENT OF TRANSPORTATION PLANS NUMBERS PLANS OF PROPOSED TITLE SHEET . TYPICAL CROSS SECTIONS MISCELLANEOUS DETAILS. MICHIGAN PROJECT STRG 0682(356) NOTE SHEET. STANDARD SYMBOLS 82211 CONTROL SECTION ALIGNMENT SHEET REMOVAL PLAN CONSTRUCTION PLAN 73160A JOB NUMBER PROFILE SHEETS DETOUR PLANS 12-18 TEMPORARY SIGN DETAILS. 19-20 M-85 AT GO1 OF 82211, CN/GTW RAILROAD CROSSING PERMANENT PAVEMENT MARKING LOG OF BORINGS SPECIAL DETAILS 23-24 SECTION 24, T4S, R10E CITY OF TRENTON WAYNE COUNTY R10E LENGTH - 0.055 MILES GO1 OF 82211 M-85 @ CN/GTW RR CONTRACT FOR REPLACEMENT OF RATLEDAD CROSSINGS RAILROAD CROSSING CS 82211 - JN 73160A, JN 73164A P.O.B. STA 467+15.00 P.O.E. STA 470+03.50 WAYNE C.S. BMP = 3.984 C.S. EMP = 4.040 COUNTY DETOUR ROUTE P.R *1592105 (NB M-85) (5.2 MILES) P.R BMP=4.076 P.R EMP=4.106 P.R. *1592106 (SB M-85) COUNTY KEY P.R. BMP = 3.916 P.R. EMP=3.948 JN 73164A CN/GTW RR FORCE ACCOUNT 145 APPROVALS RECOMMENDED FOR APPROVAL RECOMMENDED TITLE SHEET LEGEND JOHN F. SANFORD, P.E. LOURS RY ENGINEER PROPOSED PROJECT EXISTING ROADS PAVED BITUMINOUS APPROVED BY UNIMPROVED OR CITY STREET SECTION LINE TOWNSHIP LINE

COUNTY LINE

RAILROADS

CITY OR VILLAGE LIMITS.

THE IMPROVEMENTS COVERED BY THESE PLANS SHALL BE DONE IN ACCORDANCE

	5006	2026
A.D.I. NB	18,100	22,100
A.D.I. SB	18,100	22,100 2,210
D.H.V. NB	1,810	
D.H.V. SB	1,810	2,210
COMM. %	3.3%	4.5%
DESIGN SPEED	55 MPH	
DOCTED COLLO	CO MOU	

60

3

ON M-85 (FORT STREET) NB AND SB, AND ADJACENT BIKEPATH TRAIL, ASSOCIATED ROADWORK, AND MAINIAINING TRAFFIC.

> THESE PLANS WERE PREPARED FOR THE MICHIGAN DEPARTMENT OF TRANSPORTATION SPALDING DEDECKER ASSOCIATES, INC.



GORETTE YUNG PE PROJECT MANAGER Wh 1. 5 1


3/20/06 03-20-66


MICHIGAN DEPARTMENT OF TRANSPORTATION


MDOT

JEFFREY A. HORNE.

CONTROL SECTION JOB NUMBER 82211 73160A STRG 0682(356) JJ2431

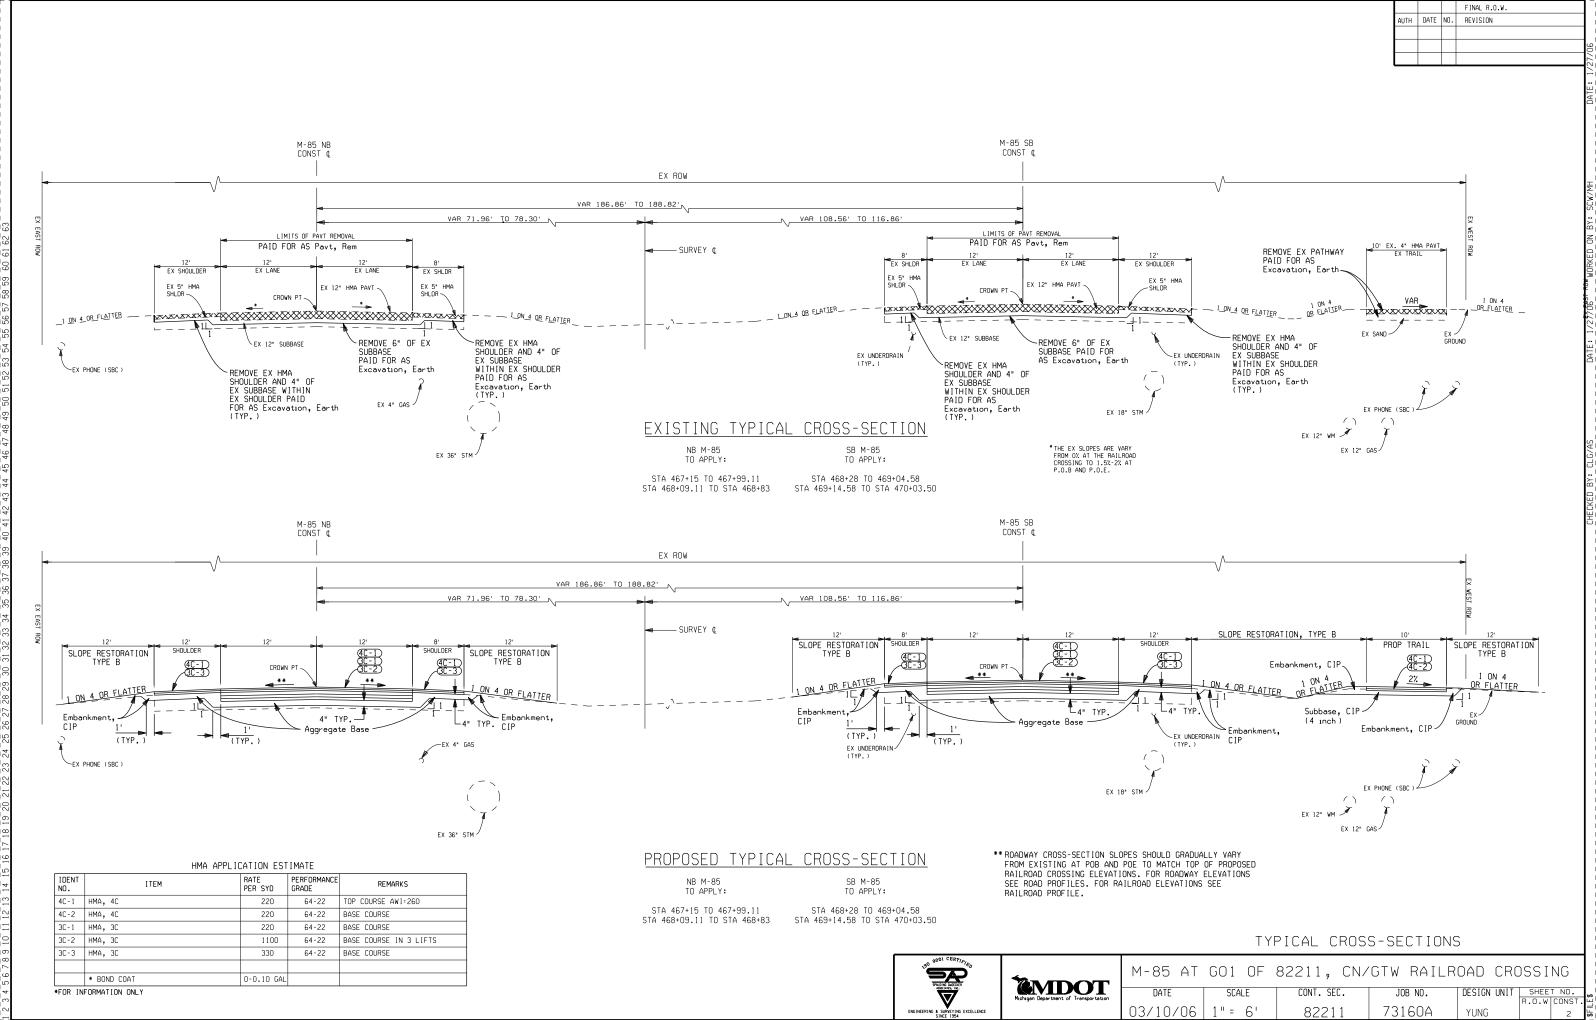

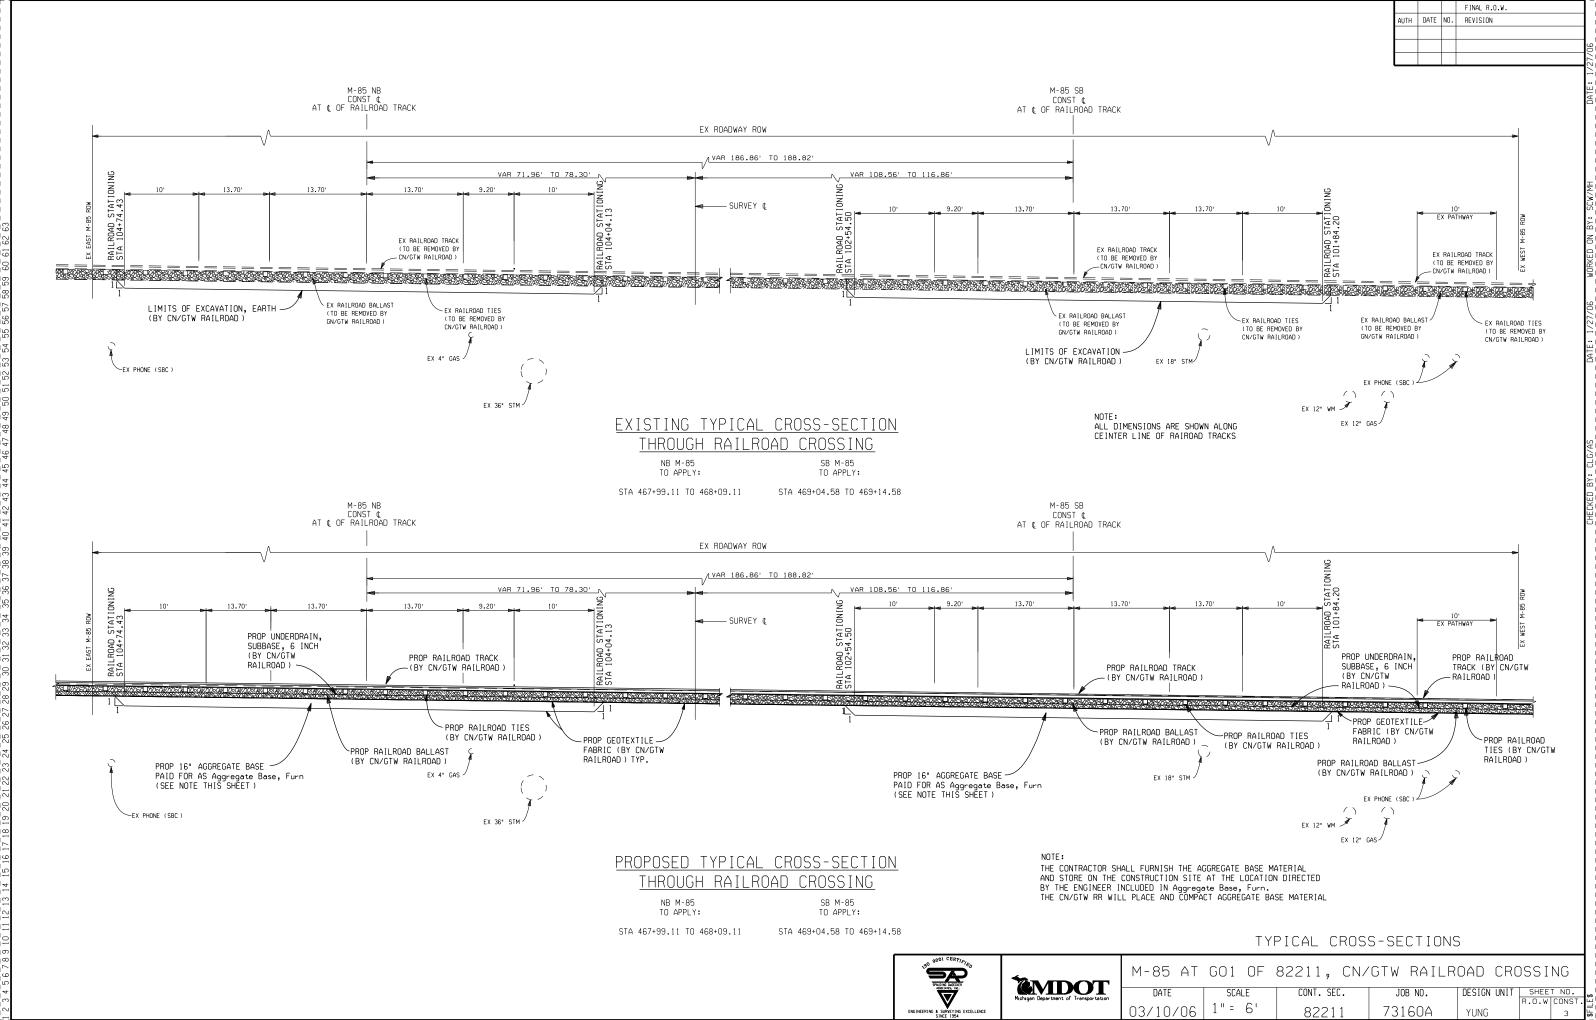

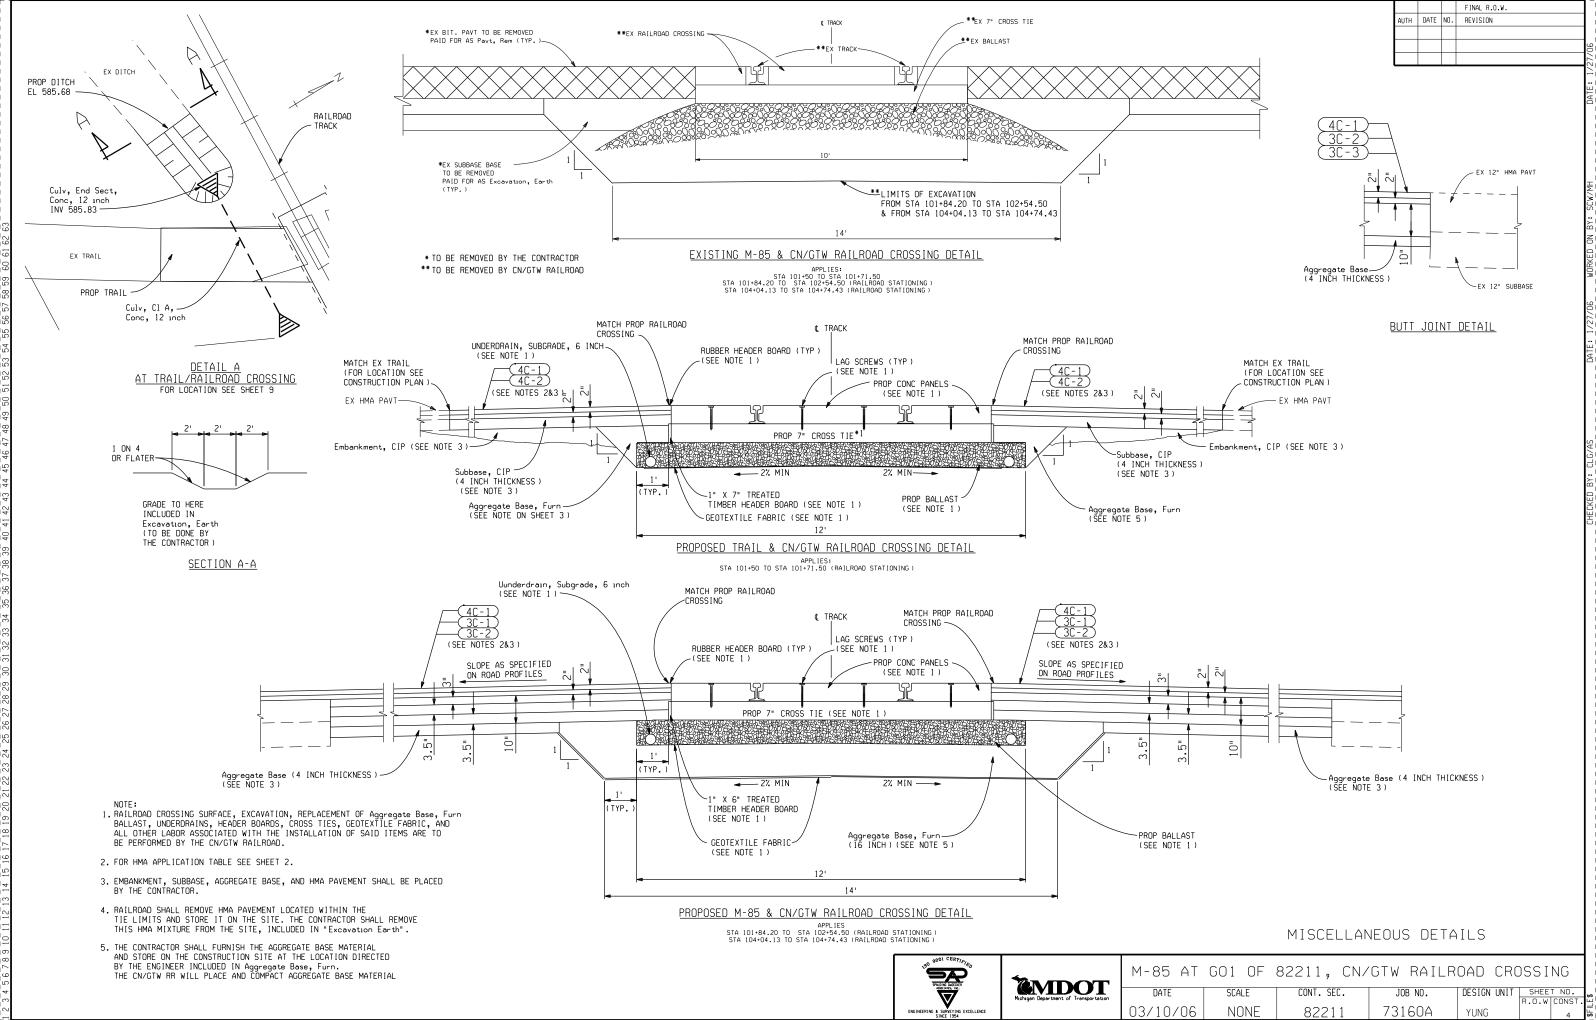

METHOD OF SURVEY REGULAR - PARTIAL		YEAR 2005
SURVEY ORDER	SURVEY CHIEF JEFFREY BARLETT, P.S.	YEAR 2005
AERIAL SURVEY NO N/A		YEAR
HORIZ DATUM NAD83	VERT DATUM NAVD88	
ROAD DESIGN INITIATED JANUARY 2006	COMPLETED FEB 2006	
PRELIMINARY PLANS BY SDA	FINAL PLANS BY SDA	

HWA AREA ENGINEER

IELD INSPECTION (GI) BY N/A

GENERAL PLAN NOTES

UNDERGROUND UTILITIES

FOR PROTECTION OF UNDERGROUND UTILITIES AND IN CONFORMANCE WITH PUBLIC ACT 53, 1974, THE CONTRACTOR SHALL DIAL 1-800-482-7171 A MINIMUM OF THREE FULL WORKING DAYS, EXCLUDING SATURDAYS, SUNDAYS, AND HOLIDAYS PRIOR TO REGINNING EACH EXCAVATION IN AREAS WHERE PURLIC LITTLITIES HAVE NOT BEEN PREVIOUSLY LOCATED. MEMBERS WILL THUS BE ROUTINELY NOTIFIED. THIS DOES NOT BELIEVE THE CONTRACTOR OF THE RESPONSIBILITY OF NOTIFYING UTILITY OWNERS WHO MAY NOT BE A PART OF THE "MISS DIG" ALERT SYSTEM.

MDOT'S FREEWAY LIGHTING SYSTEM, INTELLIGENT TRANSPORTATION SYSTEMS (ITS) AND OTHER MISCELLANEOUS ELECTRICAL SYSTEMS ARE NOT A PART OF MISS DIG. THEREFORE, CONTRACTORS SHALL CALL:

FREEWAY LIGHTING-

MDOT METRO REGION MAINTENANCE FREEWAY LIGHTING COORDINATOR: (248)583-5125

ITS-

METRO FREEWAY ITS OPERATIONS CENTER: (313)256-9800 EXT 310, OR (313)965-0777

CONTRACTORS SHALL CONTACT THE MAINTENANCE REPRESENTATIVE AT THE MDOT REGION/ISC OFFICE TO HAVE MOOT FLECTRICAL SYSTEMS STAKED.

PLAN ELEVATION

ELEVATIONS SHOWN ON THESE PLANS ARE FROM TOPOGRAPHICAL SURVEY TAKEN IN

OLD PLANS

OLD PLANS THAT PREDATE THIS PROJECT MAY BE AVAILABLE. THESE PLANS MAY BE REVIEWED IN THE TRANSPORTATION SERVICE CENTER DURING NORMAL WORKING HOURS. CS 82211 JN 27448

STATIONING

SURVEY & ON THIS PROJECT WAS TAKEN FROM OLD PLANS AND IS NOT NECESSARILY ACCURATE

VEHICLES AND MATERIALS STORAGE

THE CONTRACTOR SHALL NOT PARK ANY VEHICLES NOR STORE ANY MATERIALS ON PUBLIC RECREATIONAL PROPERTY.

PAVEMENT REMOVAL QUANTITIES

PAVEMENT REMOVAL AS SHOWN ON THE PLANS SHALL BE AT THE DISCRETION OF THE ENGINEER. IF IN HIS/HER JUDGEMENT, AREAS OF PAVEMENT MAY BE LEFT IN PLACE, OR ADDITIONAL AREAS ADDED TO PROVIDE THE PROPER CROSS-SECTION AND BASE, CHANGES CAN BE MADE IN THE QUANTITIES.

HORIZONTAL/VERTICAL DATUM

THE HORIZONTAL CONTROL IS BASED ON MICHIGAN STATE PLANE COORDINATE SYSTEM. THE VERTICAL CONTROL DATUM IS NAVD 88.

STATE PLANE COORDINATES AND DISTANCES

ALL DISTANCES AND COORDINATES ON THIS PROJECT ARE ON THE STATE PLANE COORDINATE SYSTEM. THE CONSTANT AVERAGE SCALE FACTOR IS 0.999970853

STATE PLANE DISTANCE / 0.999970853 = GROUND DISTANCE.

SAW CUTTING FOR PAVEMENT REMOVAL

WHERE EXISTING PAVEMENT IS TO BE REMOVED ADJACENT TO PAVEMENT REMAINING IN PLACE THE PAVEMENT SHALL BE SAW CUT FULL DEPTH FOR THE ENTIRE REMOVAL LENGTH AND WIDTH, THIS WORK SHALL NOT BE PAID SEPARATELY BUT SHALL BE INCLUDED IN THE CONTRACT UNIT PRICE FOR REMOVING PAVEMENT. ALL OTHER SAW CUTTING THAT MAY BE NECESSARY WILL BE CONSIDERED INCLUDED IN THE WORK WHICH IS BEING PERFORMED AND WILL NOT BE PAID FOR SEPARATELY.

CLASS A SLOPES SHALL BE REQUIRED ON THIS PROJECT.

SOIL EROSION MEASURES

APPROPRIATE SOIL EROSION AND SEDIMENTATION CONTROL MEASURES SHALL BE IN PLACE PRIOR TO EARTH-DISTURBING ACTIVITIES. PLACE TURF ESTABLISHMENT ITEMS AS SOON AS POSSIBLE ON POTENTIAL ERODABLE SLOPES AS DIRECTED BY THE ENGINEER. CRITICAL DITCH GRADES SHALL BE PROTECTED WITH EITHER SOD OR SEED/MULCH OR MULCH BLANKET AS DIRECTED BY THE ENGINEER.

SOIL BORINGS AND/OR PAVEMENT CORES

THE SOIL BORING LOGS AND/OR PAVEMENT CORES REPRESENT POINT INFORMATION. NO INFERENCE SHOULD BE MADE THAT SUBSURFACE OR PAVEMENT CONDITIONS ARE THE SAME AT OTHER LOCATIONS.

EARTHWORK

EARTHWORK QUANTITIES ARE COMPUTED BY CONVENTIONAL SURVEY METHODS.

PAVEMENT MARKINGS AND SIGNS

ALL PERMANENT PAVEMENT MARKINGS, SHAPES, AND DIMENSIONS SHALL CONFORM WITH MOOT PAVEMENT MARKING TYPICALS VIII-900 THRU 990 SERIES UNLESS SPECIFIED BY SPECIAL PROVISION. ALL EDGE LINES SHALL BE 6 INCHES AND ALL GORE MARKINGS SHALL BE 12 INCHES. DEESETS FROM CONSTRUCTION JOINTS SHALL REMAIN AS NOTED IN THE PAVEMENT MARKING TYPICALS. ALL PERMANENT SIGNS SHALL CONFORM WITH MOOT SIGNING TYPICAL PLANS VIII-100 THRU 830 SERIES UNLESS SPECIFIED BY SPECIAL PROVISION.

PERMANENT SIGNS

ANY PERMANENT SIGNS REQUIRING RELOCATION DUE TO CONTRACTOR OPERATIONS SHALL BE SALVAGED AND RESET BY THE CONTRACTOR AT LOCATIONS DESIGNATED BY THE ENGINEER. THE COST OF THIS WORK SHALL BE BORNE BY THE CONTRACTOR.

AGGREGATE BASE UNDER HMA

AGGREGATE BASES TO BE SURFACED WITH HMA SHALL USE AGGREGATE 22A, UNLESS OTHERWISE SPECIFIED.

UTILITIES

HE EXISTING UTILITIES LISTED BELOW AND SHOWN ON THESE PLANS REPRESENT THE BEST INFORMATION AVAILABLE AS OBTAINED ON OUR SURVEYS DATED MARCH 2004. THIS INFOR-MATION DOES NOT RELIEVE THE CONTRACTOR OF THE RESPONSIBILITY TO BE SATISFIED AS TO ITS ACCURACY AND THE LOCATION OF EXISTING UTILITIES.

NAME OF OWNER KIND OF UTILITY TELEPHONE 31100 PLYMOUTH ROAD LIVONIA, MI 48150 GREG GIÁNNETTI (734) 523-7572 DTE ENERGY ELECTRIC 2000 2ND AVE. DETROIT, MI 48226 ANJANETTE BORAWSKI (313) 235-9284

WATER & SEWER

MICHCON GAS 3200 HORSON DETROIT, MI 48201 (313) 577-7327

DEPARTMENT OF PUBLIC WORKS 1431 WEST ROAD TRENTON, MI 48183 LAWRENCE DUSINCKI

(734) 675-8470

QWEST COMMUNICATIONS FIBER OPTIC CABLE

1860 LINCOLN STREET, 2ND FLOOR DENVER, COLORADO 80295 (303) 837-3984

THE LOCATION OF ALL PUBLIC UTILITIES SHOWN ON THESE PLANS IS TAKEN FROM THE BEST AVAILABLE DATA. THE MICHIGAN DEPARTMENT OF TRANSPORTATION WILL NOT BE RESPONSIBLE FOR ANY OMISSION OR VARIATIONS FROM THE LOCATIONS SHOWN PURSUANT TO ACT 53 OF THE PA OF 1974 AS A CONDITION OF THIS CONTRACT NOTICE SHALL BE GIVEN TO MISS DIG 3 WORKING DAYS PRIOR TO UNDERGROUND WORK TO BE PERFORMED IN ACCORDANCE WITH THIS CONTRACT. PHONE (800) 482-7171 OR

NOTES APPLYING TO STANDARD PLANS

WHERE THE FOLLOWING ITEMS ARE CALLED FOR ON PLANS, THEY ARE TO BE CONSTRUCTED ACCORDING TO THE STANDARD PLAN GIVEN BELOW OPPOSITE EACH ITEM UNLESS OTHERWISE

GRANULAR BLANKET, UNDERDRAINS, OUTLET ENDINGS FOR UNDERDRAINS, AND SEWER BULKHEADS	R-80-C
BEDDING AND FILLING AROUND PIPE CULVERTS	R-82-D
PRECAST CONCRETE END SECTION FOR PIPE CULVERT	R-86-D
SOIL EROSION AND SEDIMENTATION CONTROL MEASURES	R-96-C
SODDING, SEEDING AND TREE PLANTING	R-100-D
TRACK CROSSINGS	R-121-B
TEMPORARY TRAFFIC CONTROL DEVICES	R-125-D

* SPECIAL DETAIL

MISCELLANEOUS ITEMS - JN 73160A

Contractor Staking*

Staking Plan Errors and Extras, One Person Staking Plan Errors and Extras, Two Person Hr Staking Plan Errors and Extras, Three Person Cyd Syd Subgrade Undercutting, Type II 2,883 Slope Restoration, Type B Water, Sodding/Seeding 10 Dr Marker Post Ea Ft Exploratory Trenching Non Haz Contaminated Material Handling and Disposal, LM

Cyd Ton 262 Aggregate Base, Furn Еa Underdrain, Outlet Ending, Furn 10 Cyd Maintenance Gravel, LM

* THE "Contractor Staking" SHALL INCLUDE STAKING TOP OF THE RAIL ELEVATIONS AND LIMITS OF EXCAVATION UNDER THE RAILROAD CROSSING.

SOIL EROSION AND SEDIMENTATION CONTROL ITEMS:

1,100 Ft Erosion Control, Silt Fence Erosion Control, Sediment Trap Erosion Control, Maintenance, Sediment Removal Еa 20 Cyd Syd Riprap, Plain


MAINTAINING TRAFFIC ITEMS


Fence, Protective Post, Wood, 6 inch by 8 inch, Direct Embedment 1,000 Ft Barricade, Type III, High Intensity, Lighted, Furn Barricade, Type III, High Intensity, Lighted, Oper Ea Εa Barricade, Type III, High Intensity, Double Sided, Ea Lighted, Furn Ea Barricade, Type III, High Intensity, Double Sided, Lighted, Oper Lighted Arrow, Type C, Furn Ea Lighted Arrow, Type C, Oper Εa Minor Traf Devices 600 Pavt Mrkg, Longit, 6 inch or Less Width, Rem Pavt Mrkg, Type R, 4 inch, White, Temp Pavt Mrkg, Type R, 4 inch, Yellow, Temp Plastic Drum, High Intensity, Lighted, Furn 1850 1700 Ft Ft. 200 Fa 200 Plastic Drum, High Intensity, Lighted, Oper Еa Sign, Portable, Changeable Message, Furn Ea Sft Sign, Portable, Changeable Message, Oper 670 Sign, Type B, Temp, Furn 670 Sft Sign, Type B, Temp, Oper 2,400 Sft Sign, Type B, Temp, Prismatic, Furn 2,400 Sign, Type B, Temp, Prismatic, Oper


PERMANENT PAVEMENT MARKINGS & DELINEATORS

700 Pavt Mrkg, Spray Thermopl, 4 inch, White Ft. Pavt Mrkg, Spray Thermopl, 6 inch, White 360 Pavt Mrkg, Spray Thermopl, 6 Inch, Yellow Pavt Mrkg, Primerless Patterned Tape, 24 in, Stop Bar Ft 50

NOTE SHEET MDOT DATE CONT. SEC. SHEET NO. JOB NO. DESIGN UNIT R.O.W CONST 03/10/06 82211 73160A

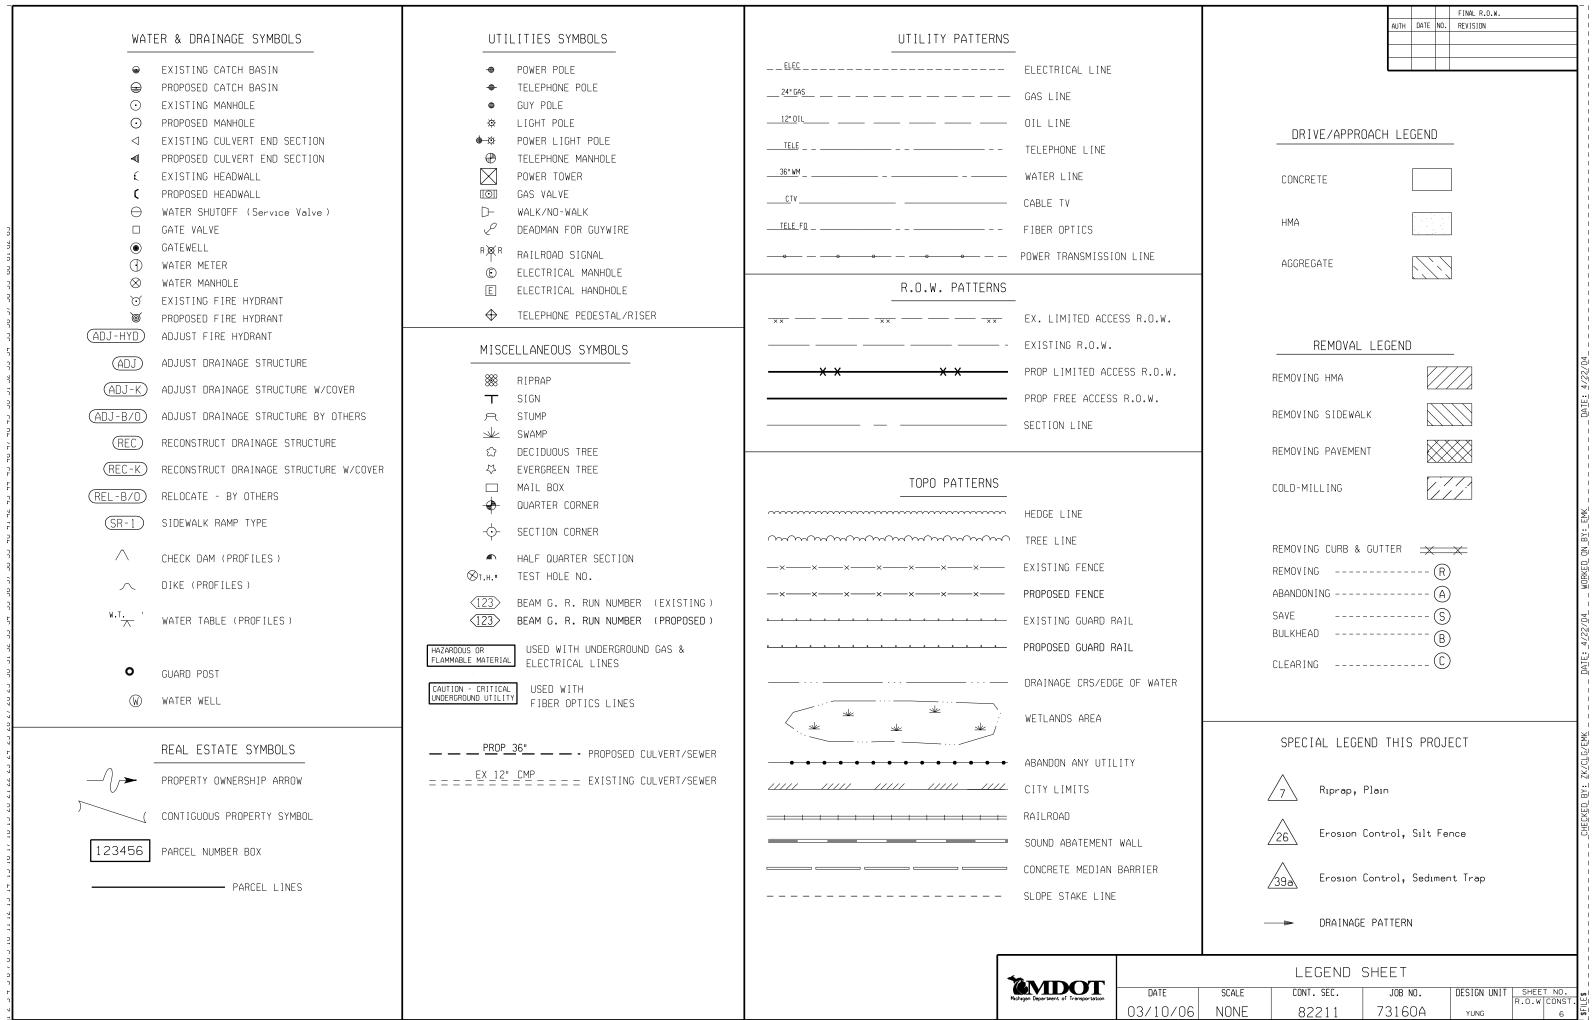

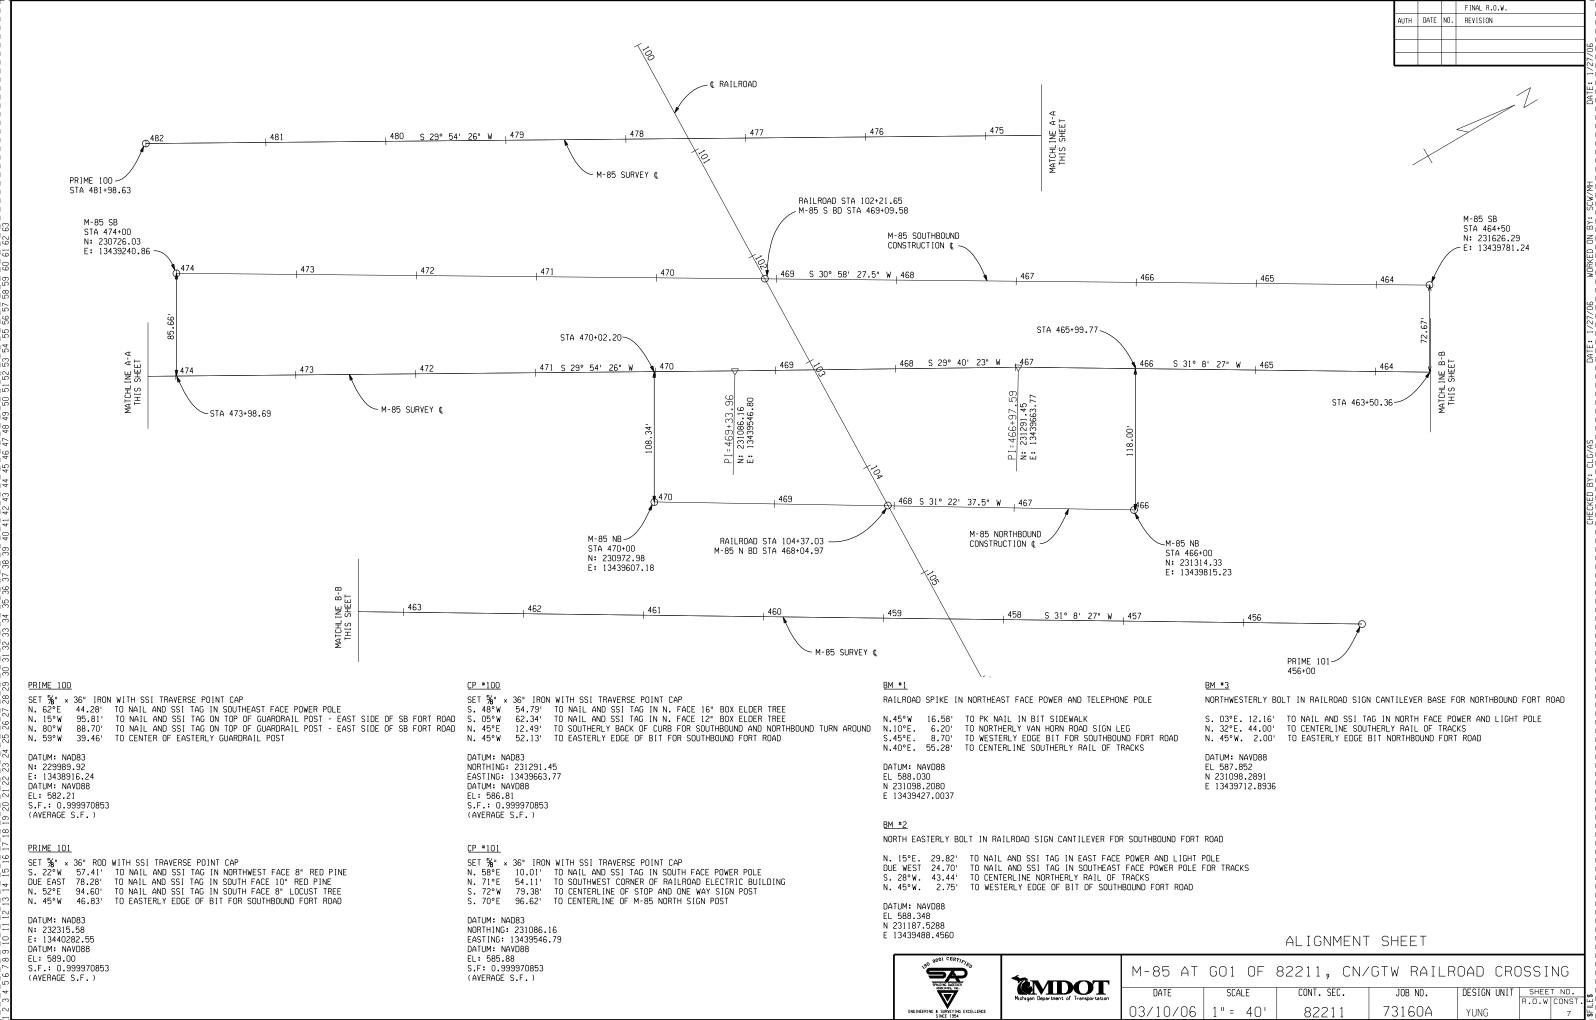

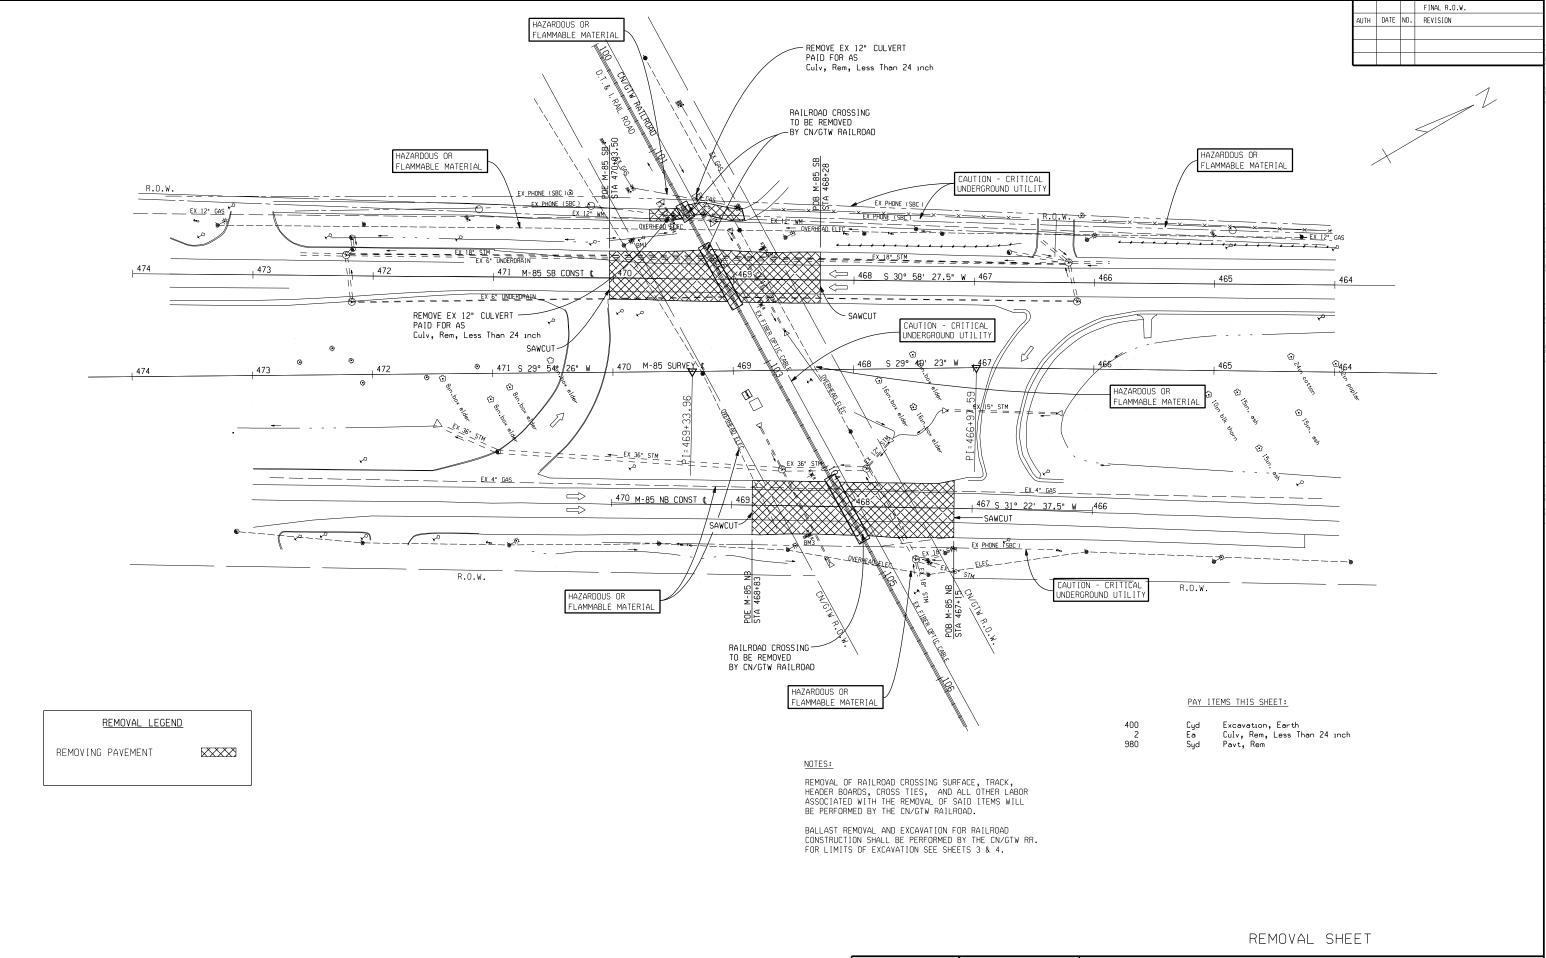






M-85 AT GO1 OF 82211, CN/GTW RAILROAD CROSSING


DATE | SCALE | CONT. SEC. | JOB NO. | DESIGN UNIT | SHEET NO. | R.O.W | CONST. |


03/10/06 | 1" = 40' | 82211 | 73160A | YUNG | 8

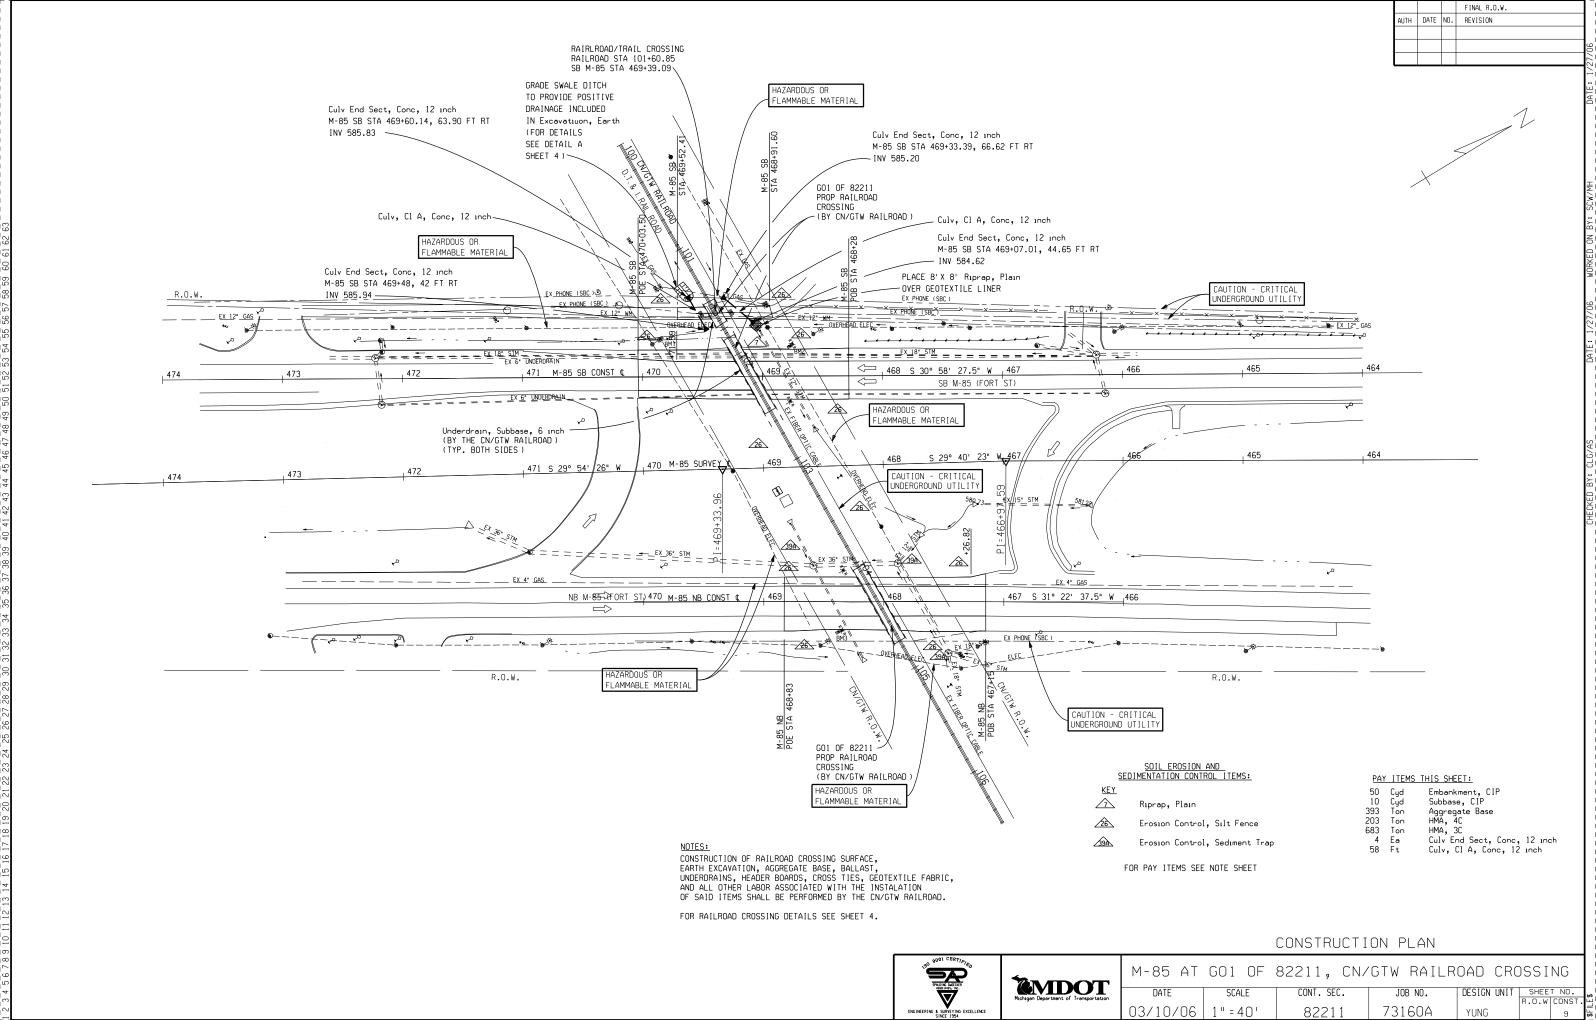

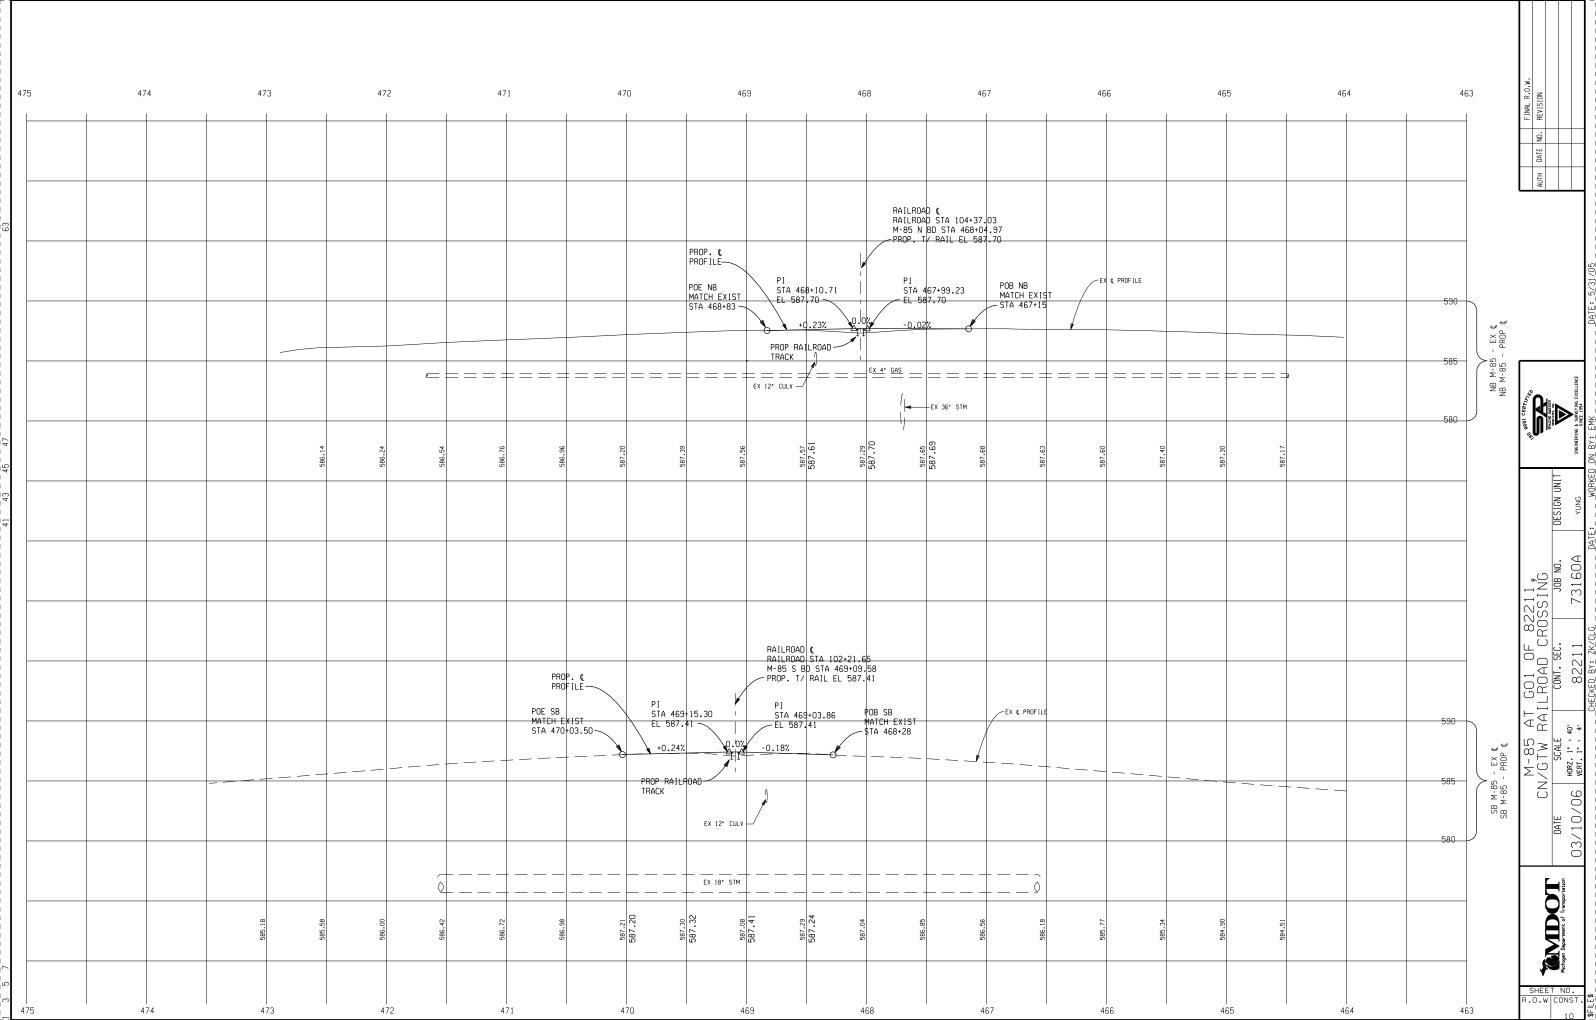


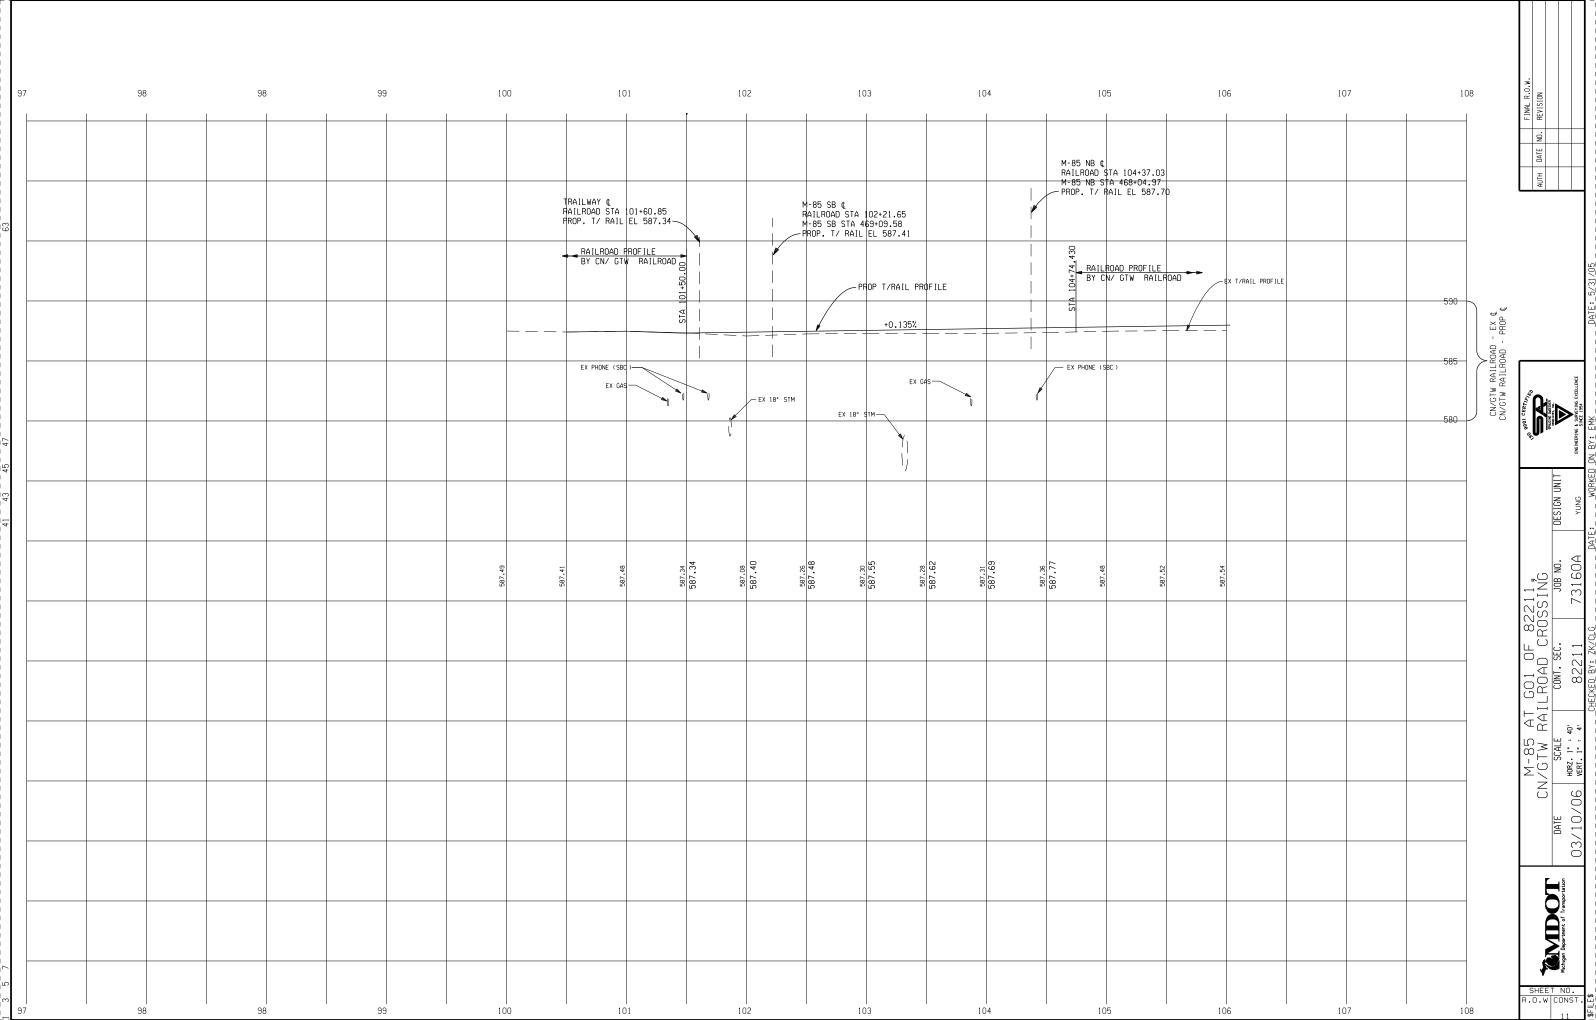

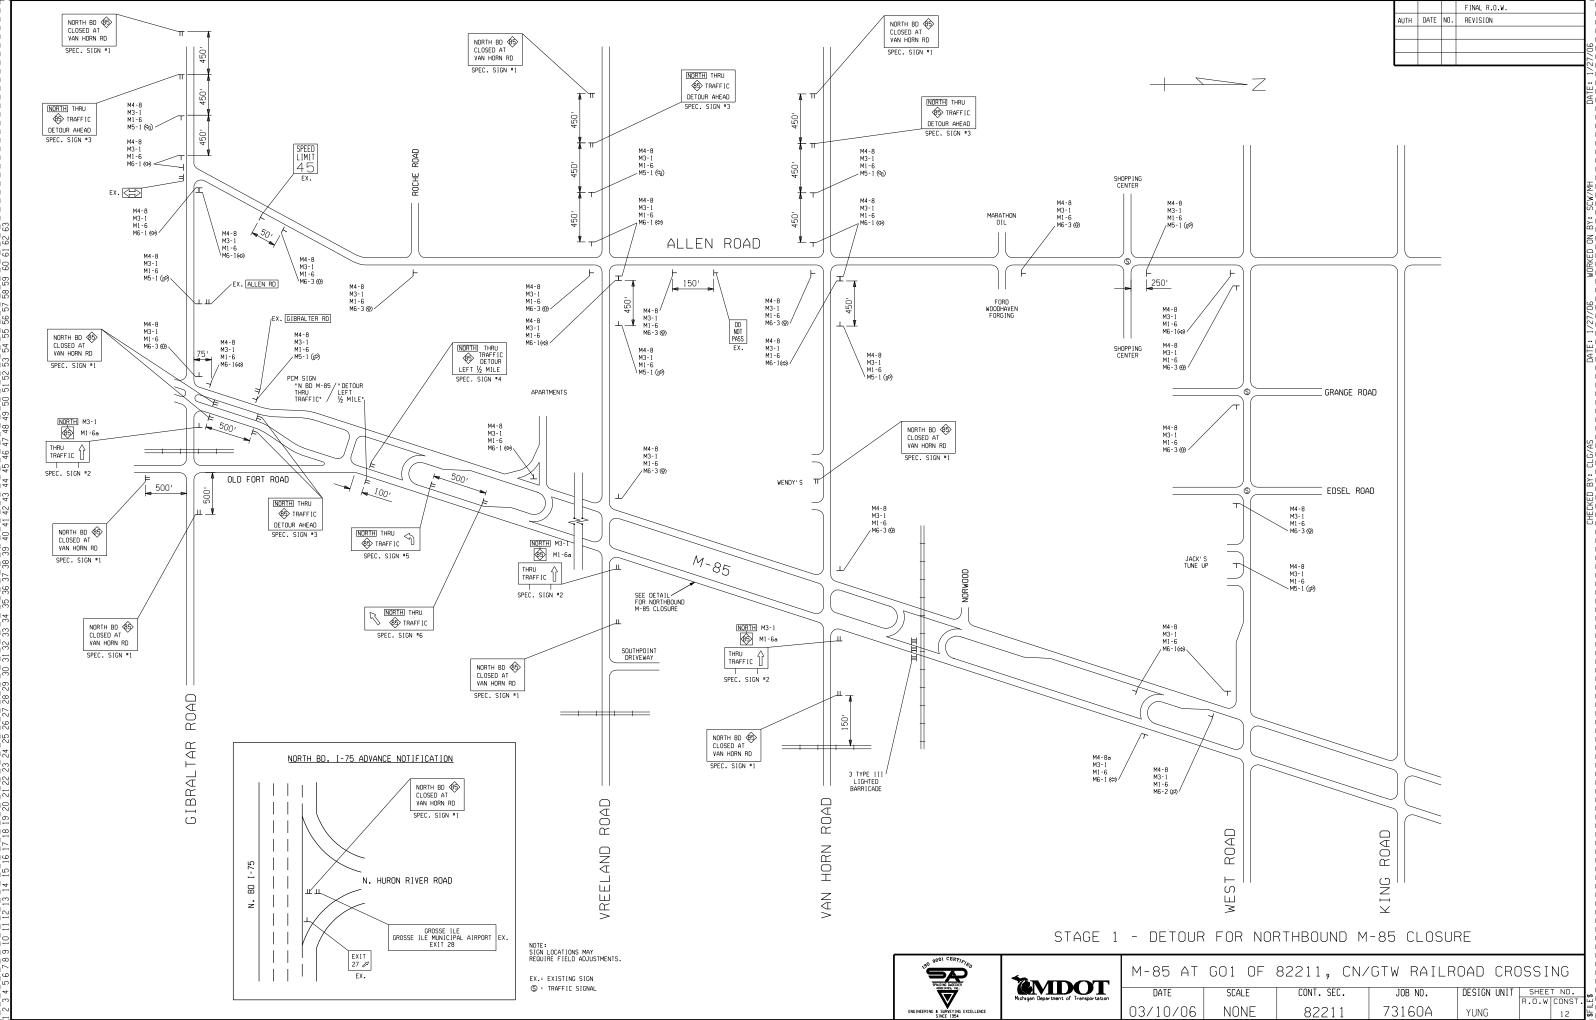

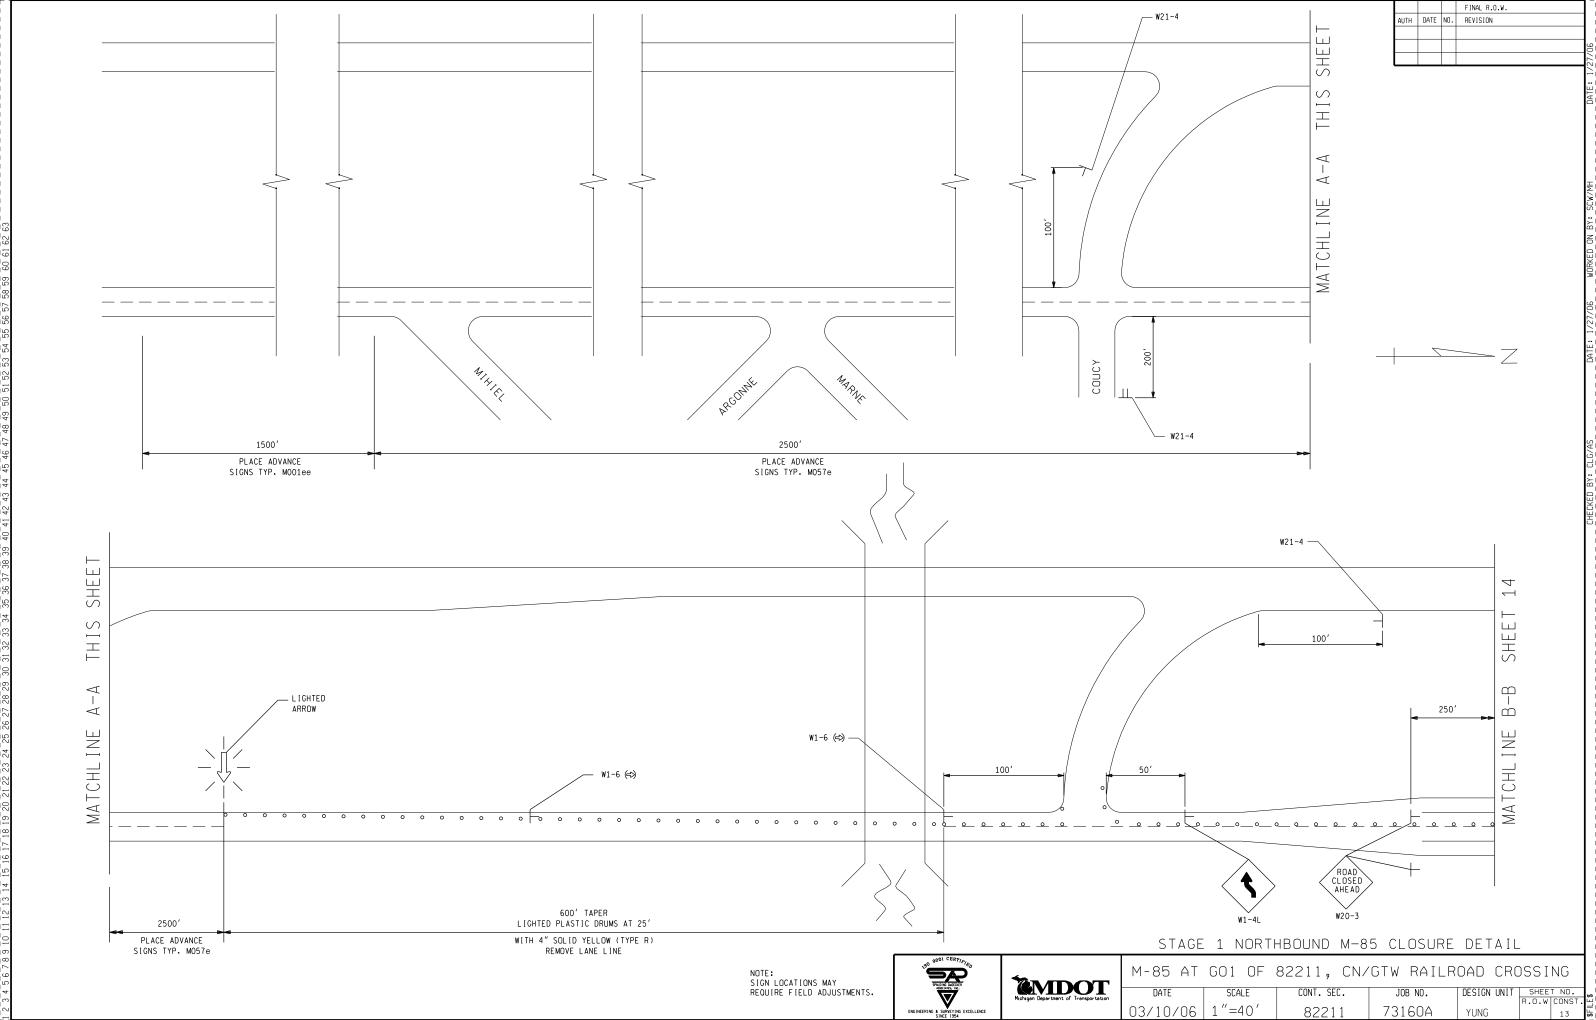


			FINAL R.U.W.	
AUTH	DATE	NO.	REVISION	
				yu
				1/1
				1

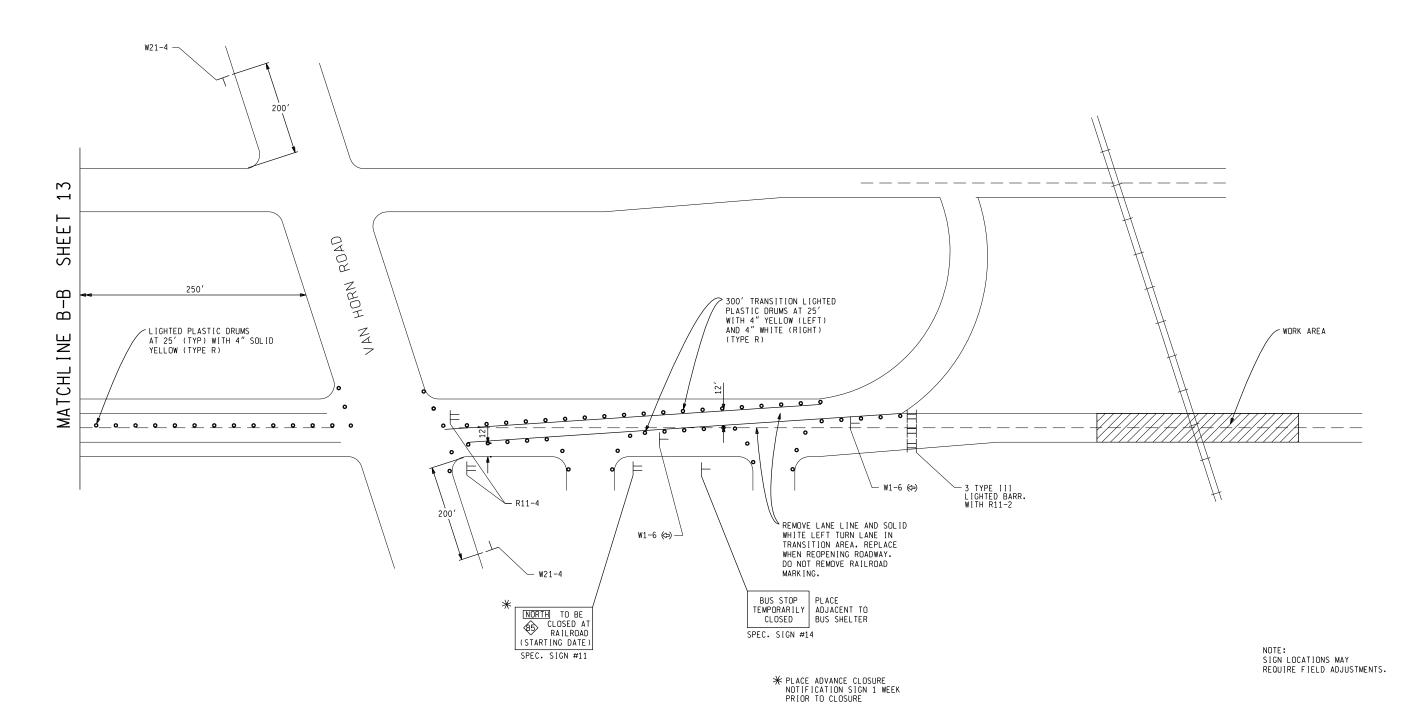

STAGE 1 NORTHBOUND M-85 CLOSURE DETAIL




M-85 AT	GO1 OF	82211, CN/	GTW RAILR	OAD CRO)SSING
DATE	SCALE	CONT. SEC.	JOB NO.	DESIGN UNIT	SHEET NO. R.O.W CONST.
03/10/06	1"=40'	82211	73160A	YUNG	14

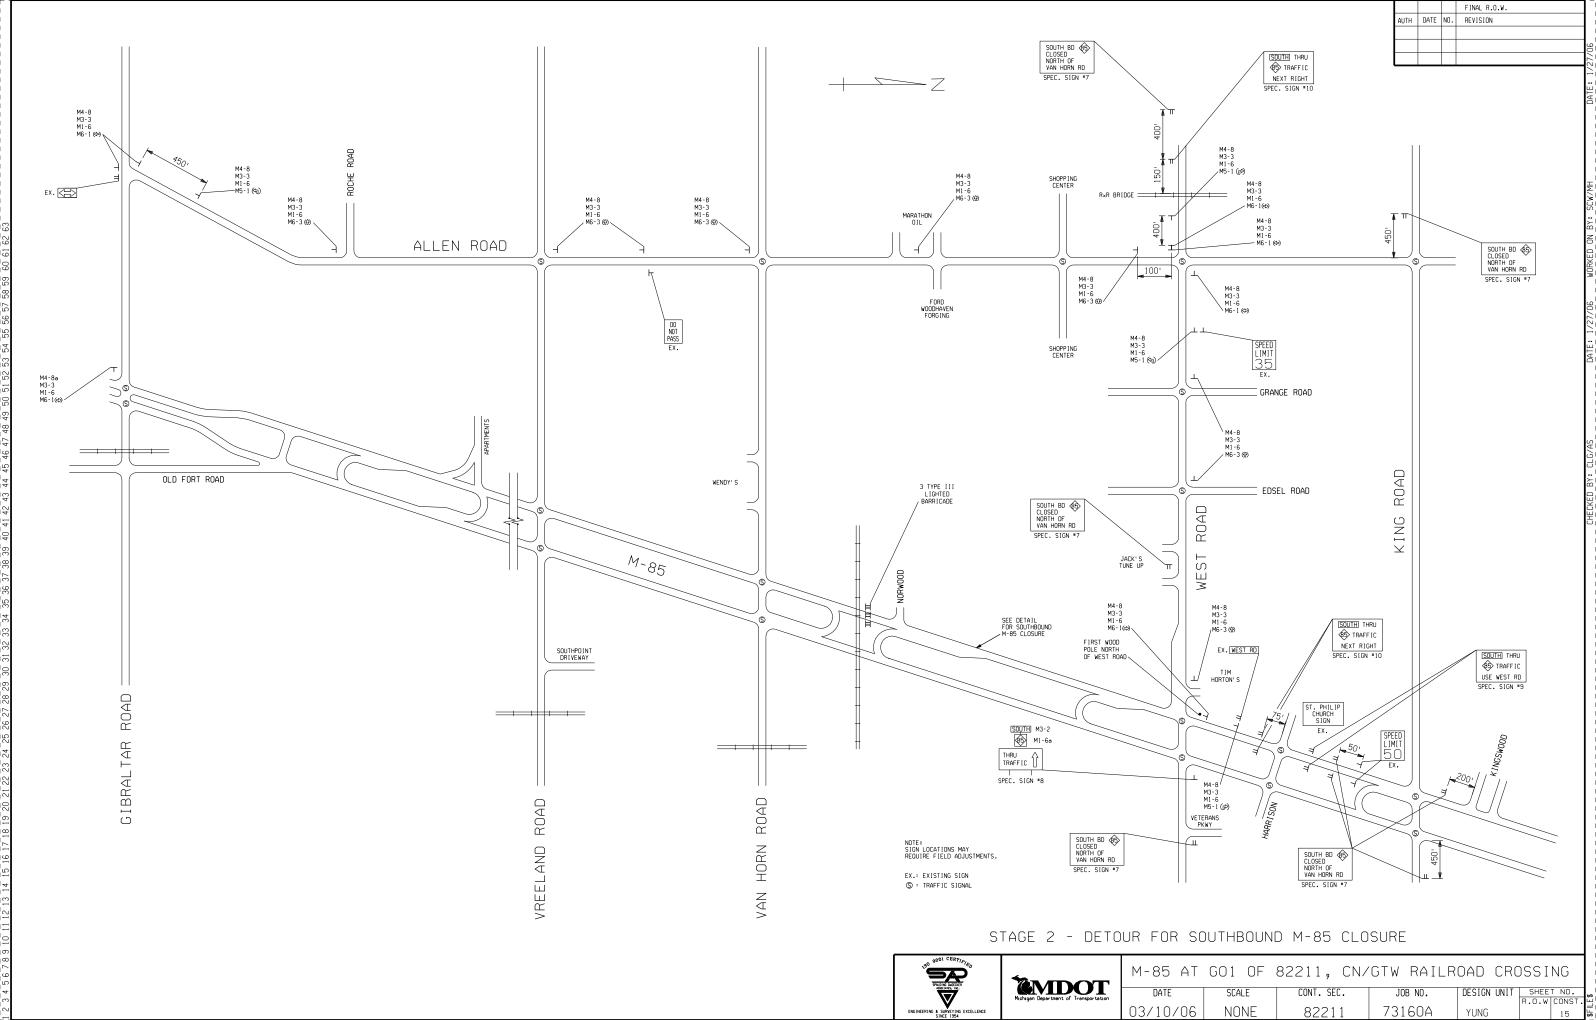

			FINAL R.O.W.	1 1
AUTH	DATE	NO.	REVISION	Н
				90
				1/2
				10

7

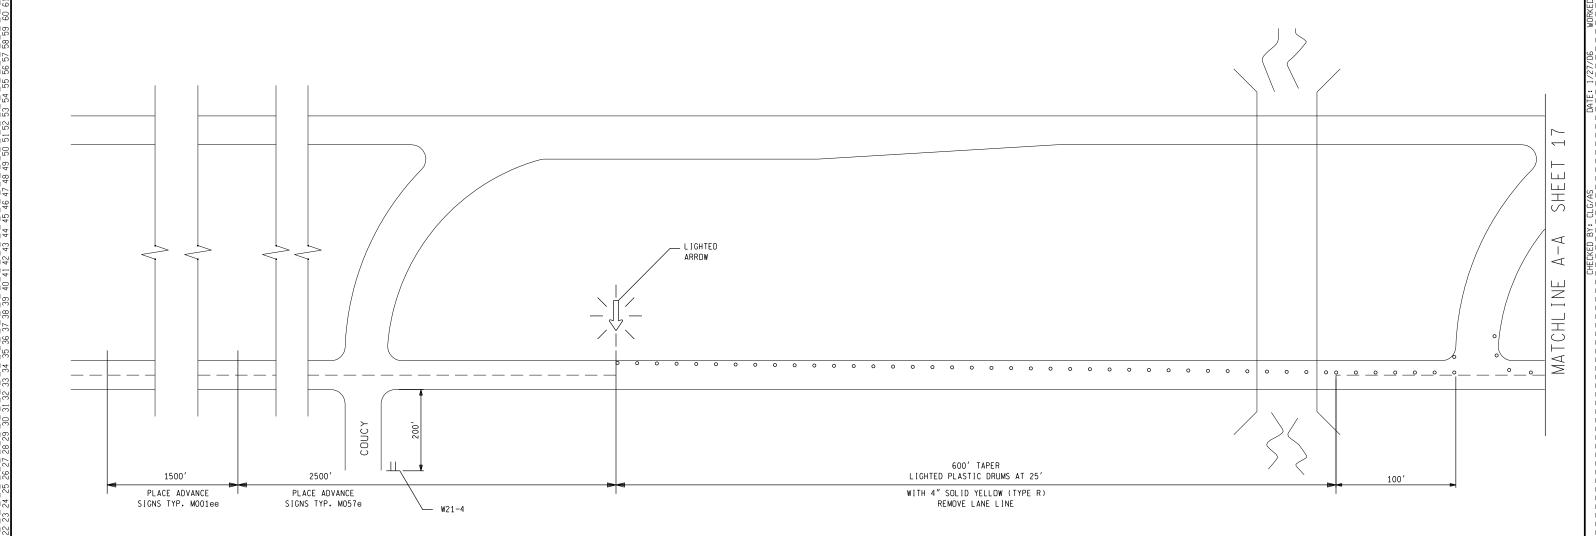

NOTE: SIGN LOCATIONS MAY REOUIRE FIELD ADJUSTMENTS.

STAGE 2 SOUTHBOUND M-85 CLOSURE DETAIL




Michigen Department of Transportation

M-85 AT GO1 OF 82211, CN/GTW RAILROAD CROSSING

		,			
DATE	SCALE	CONT. SEC.	JOB NO.	DESIGN UNIT	SHEET NO.
					R.O.W CONST
L 03/10/06	1 "=40"	82211	l 73160A	YUNG	1 16

			FINAL R.U.W.
AUTH	DATE	NO.	REVISION

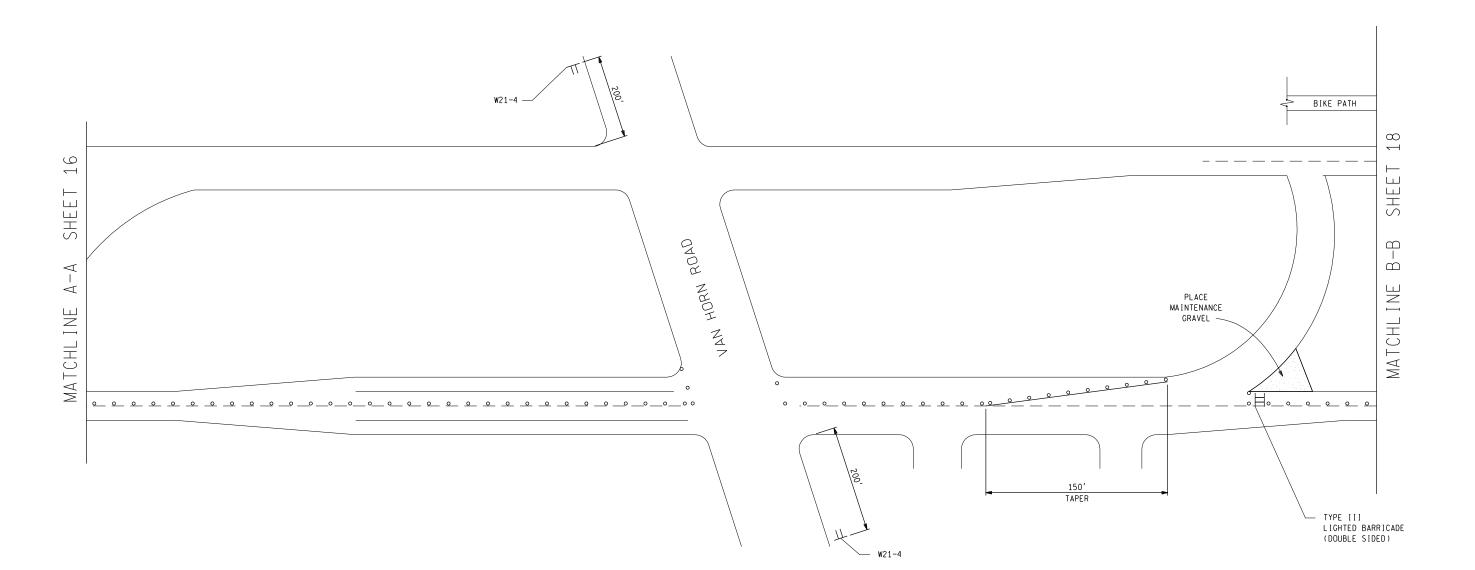


NOTE: SIGN LOCATIONS MAY REQUIRE FIELD ADJUSTMENTS.


STAGE 2 SOUTHBOUND M-85 CLOSURE DETAIL



	M-85	ΑT	GO 1	OF	82211,	CN/	G
\mathbf{OT}					•		
O,L	DATE		SCA	LE	CONT. SE	.C.	


M-85 AT	GO1 OF	82211, CN/	GTW RAILR	OAD CRO	DSSING
DATE	SCALE	CONT. SEC.	JOB NO.	DESIGN UNIT	SHEET NO
03/10/06	1 "=40 '	82211	73160A	YUNG	17

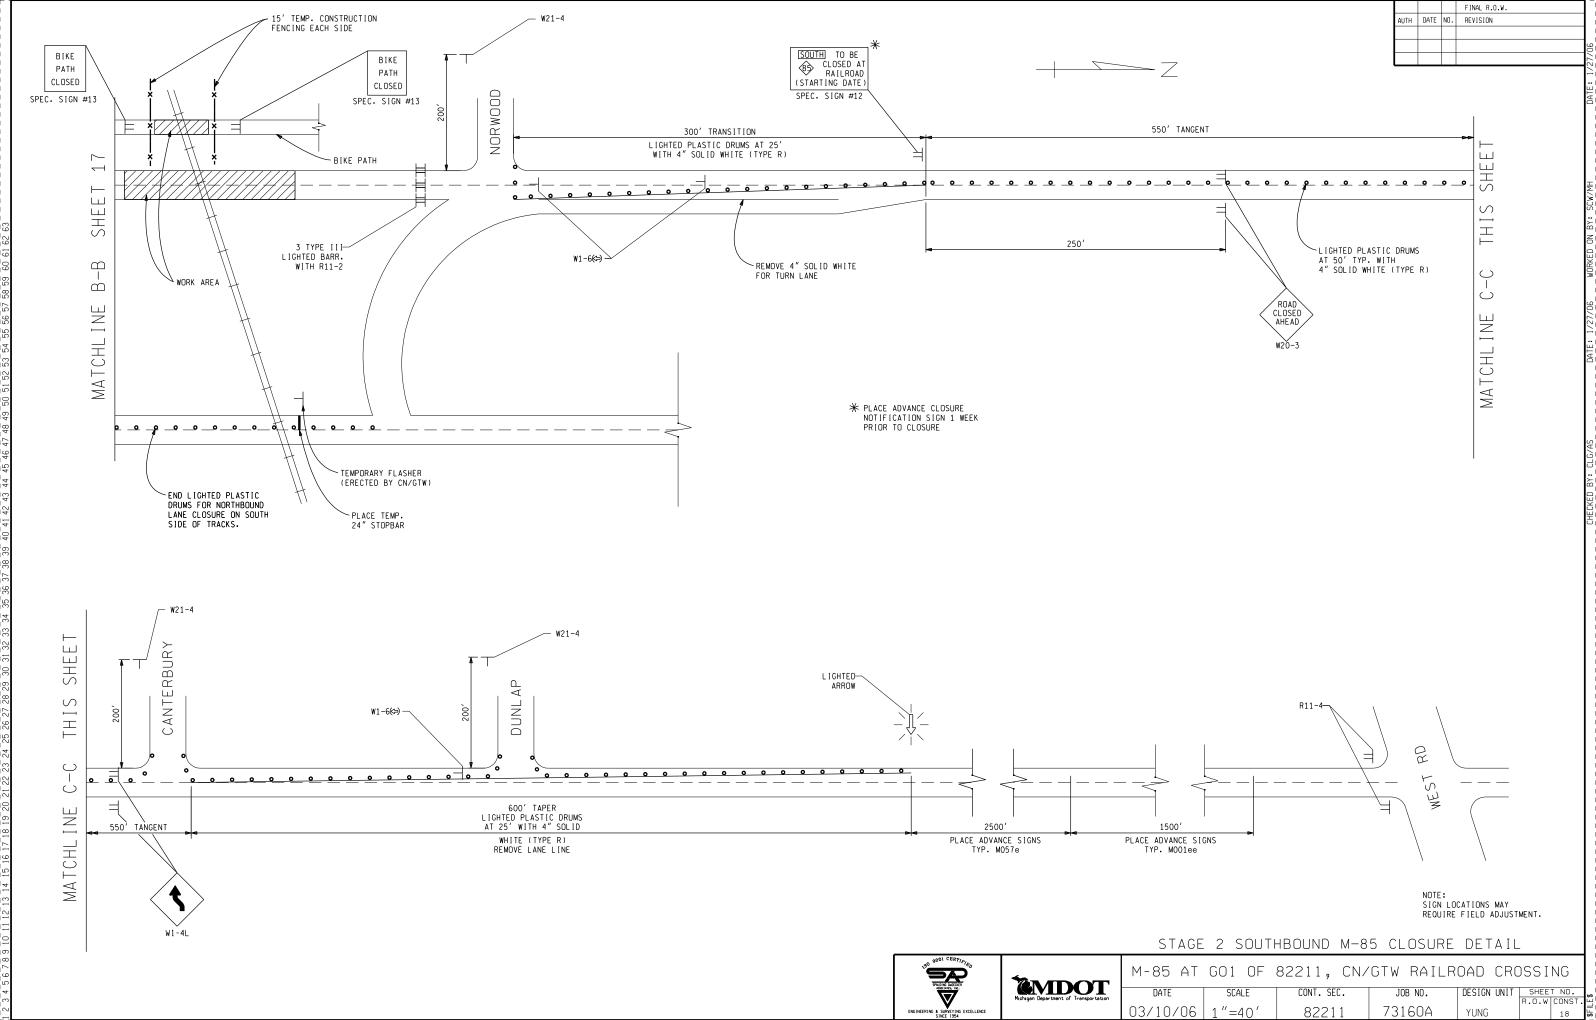

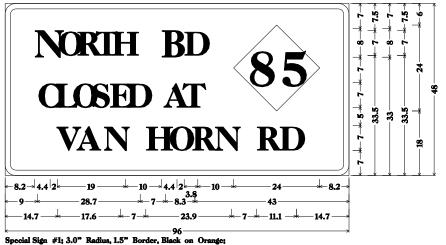

[N ORTH] C; [B D] C; [CLOSED AT] C; State Highway 85 M1-6a; IVAN HORN RDI D: Table of widths and spaces


14.7 5.3 0.4 5.9 1.3 4.7 7.0 4.7 1.6 4.9 1.7 4.7 1.6 4.7 7.0 4.7 1.7 4.7 1.6 4.7 7.0 4.7 1.7 1

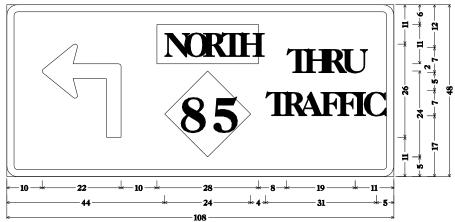

90 Deg Advanced Turn Arrow Custom 22" X 26"; Rectangle White; State Highway 85 M1-6a; [THRU] C; [TRAFFIC] C; Table of widths and spaces.


10 22 10 28 8 4 1 4 1 4 1 4 11




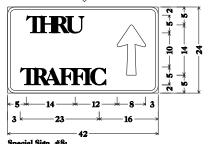


[THRU] C; [TRAFFIC] C; Arrow B-8 - 14" 90{;

		. ***	au.u	******	apa									
5	T 3	1	H 2	1	R 3	1	U 3	12	8	3				
3	T 3	1	R 3	0	A 4	0	F 3	1	F 2	1	I	1	C 3	

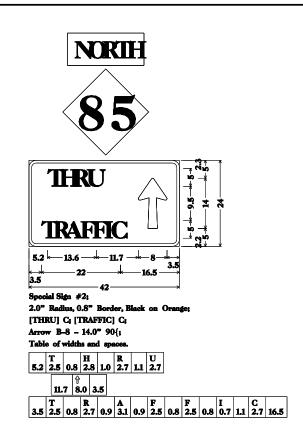


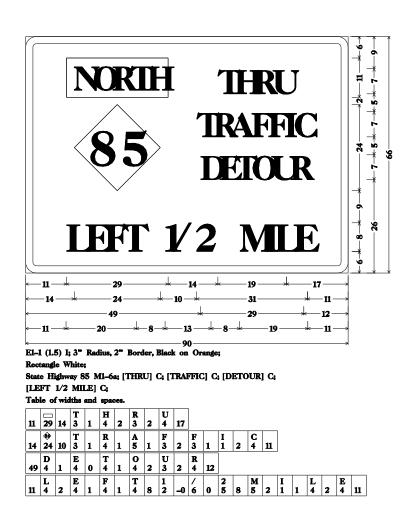

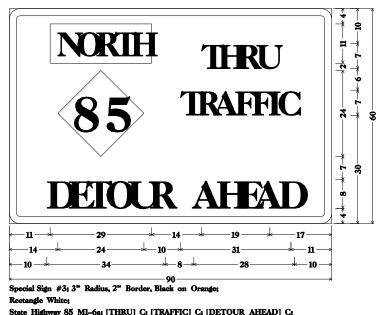

State Highway 85 M1-6a; [THRU] C; [TRAFFIC] C; [DETOUR AHEAD] C;

11	 29	14	T 3	1	H 4	2	R 3	2	U 4	17													
14		10	T 3	1	R 4	1	A 5	1	F 3	2	F 3	1	I 1	2	C 4	11							
10	D 5	2	E 4	0	T 4	2	0	2	U 4	2	R 5	8	A 5	1	H 4	2	E 4	1	A 5	1	D 5	10	

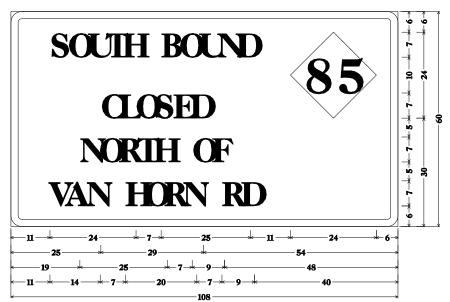

[SOUTH BOUND] C; [CLOSED] C; [NORTH OF] C; [VAN HORN RD] C; State Highway 85 M1-6a;

	S		0		U		T		H		В		0		U		N		D		�	
11	4	1	4	1	4	1	4	1	4	7	4	1	4	1	4	2	4	1	4	11	24	6
	C		L		0		S		E		D											
25	4	1	4	1	4	1	4	1	4	1	4	54										
	N		0		R		T		H		0		F]							
19	4	2	4	1	4	1	4	1	4	7	4	1	4	48								
	v		A		N		н		0		R		N		R		D]			
11	4	1	1 A	1	4	7	4	1	4	2	4	1	4	7	4	1	4	40				

SPECIAL SIGNS




1-85 AT	GO 1	OF	82211,	CN/GTW		

JOB NO. 82211 73160A


AUTH DATE NO. REVISION

MDOT CONT. SEC. 03/10/06 NONE

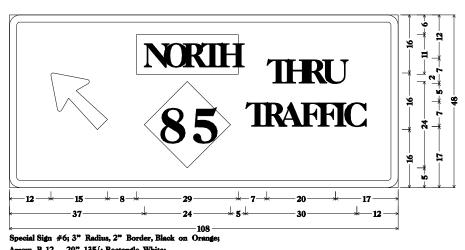

Arrow B-12 - 20" 135{; Rectangle White; State Highway 85 M1-6a; [THRU] C; [TRAFFIC] C; Table of widths and spaces.


12	\(\sigma\)	8	 29	7	T 4	1	H 4	1	R 4	2	U 4	17				
37		5	T 3	1	R 4	1	A 5	1	F 3	2	F 3	1	I 1	2	C 3	12

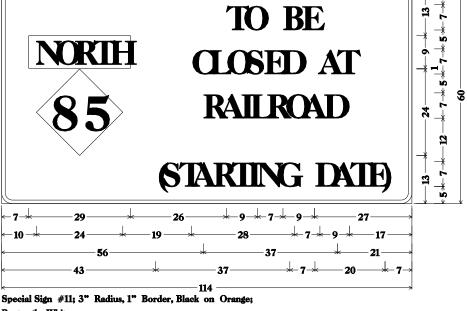

State Highway 85 M1-6a; [TO BE] C; [CLOSED AT] C; [RAILROAD] C; [(STARTING DATE)] C:

Table of widths and spaces.

7	 29	26	T 4	1	4)	7	B 4	1	E 4		27							
10	∳ 24	19	C 3	2	I 3	,	1	0 4	2	S		2	E 3	2	D 3	7	A 5	0	T 4
56	R 4	1	A 4	2	I 1		1	L 4	1	R 4		t	0 4	1	A 4	2	D 3	21	
43	(1	0	S 4	1	14		0	A 5	1	R 4	- 1	L	T 3	1	I 1	2	N 4	1	G 4
	7	. [D	1	A 4	,	1 3			E 3	0)		,	1	1			

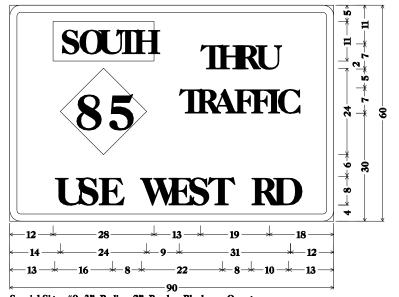


Special Sign #9; 3" Radius, 2" Border, Black on Orange;

State Highway 85 M1-6a; [THRU] C; [TRAFFIC] C; [USE WEST RD] C;

Table of widths and spaces.


12	 28	13	T 3	2	H 3	2	R 4	1	U 4	18								
14	€924	9	T 4	1	R 4	1	A 4	1	F 4	1	F 4	1	I 1	1	C 4	12		
13	U 4	2	S	2	E 4	8	W 6	1	E 4	1	S 5	1	T 4	8	R 4	2	D 4	13

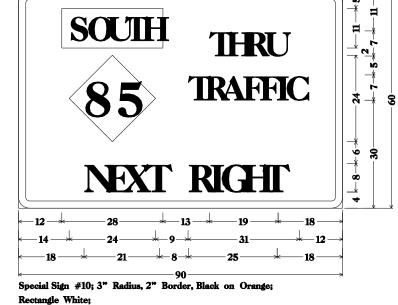

State Highway 85 M1-6a; [THRU] C; [TRAFFIC] C; [NEXT RIGHT] C;

Table of widths and spaces.

12	 28	13	T 3	2	H 3	2	R 4	1	U 4	18								
14	€ 24	9	T 4	1	R 4	1	A 4	1	F 4	1	F 4	1	I 1	1	C 4	12		
18	N 5	1	E 4	2	X 4	1	T 4	8	R 5	1	I 1	2	G 4	2	H 4	2	T 4	18

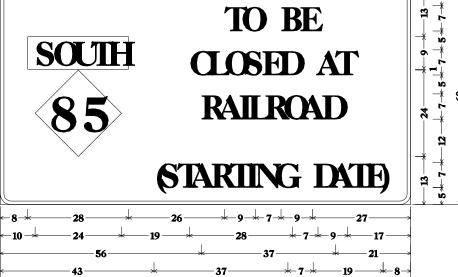

Special Sign #12; 3" Radius, 1" Border, Black on Orange;

State Highway 85 M1-6a; [TO BE] C; [CLOSED AT] C; [RAILROAD] C; [(STARTING DATE)] C:

- 114 -

Table of widths and

10 24		C 3	2	L		0		_									
			4	3	1	4	1	S	2	E 3	1	D 4	7	A 5	0	T 4	17
56 R	1	A 4	1	I 1	2	L 3	2	R 3	2	0 4	1	A 4	1	D 4	21		
43 (0	S 4	1	T 4	0	A 4	2	R 3	2	T 3	1	I 1	2	N 4	1	G 4	




2" Radius, 1" Border, Black on Orange; [BIKE] C: [PATH] C: [CLOSED] C;

Table of widths and spaces.

10	B 4	1	I 1	2	K 3	2	E 3	10			16	3
9	P 4	1	A 4	1	T 3	1	H 4	9				
4	C 3	2	L 3	1	0 4	2	S 3	2	E 3	2	D 3	4

BUS STOP **TEMPORARILY** CLOSED

FINAL R.O.W.

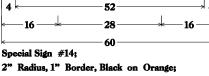

2" Radius, 1" Border, Black on Orange; [BUS STOP] C; [TEMPORARILY] C; [CLOSED] C;

Table of widths and spaces.

10	B 4	1	U 4	1	S																
	7	- 1	S	ı	Γ 4]	ı	0 4	1	P 4	10											
4	T 3	1	E 4	1	M 5	1	P 4	1	4	2	R 3	2	A 4	1	R 4	2	I 1	1	L 3	1	Y 4
16	C 3	2	L 3	1	0	2	S	2	E 3	2	D 3	16									


SPECIAL SIGNS





M-85 AT GO1 OF 82211, CN/GTW RAILROAD CROSSING

	001 01	022119 0117	OIW INHILIN	OHD CINC	7551110
DATE	SCALE	CONT. SEC.	JOB NO.	DESIGN UNIT	SHEET NO.
					R.O.W CONST
03/10/06	NONE	82211	73160A	YUNG	20

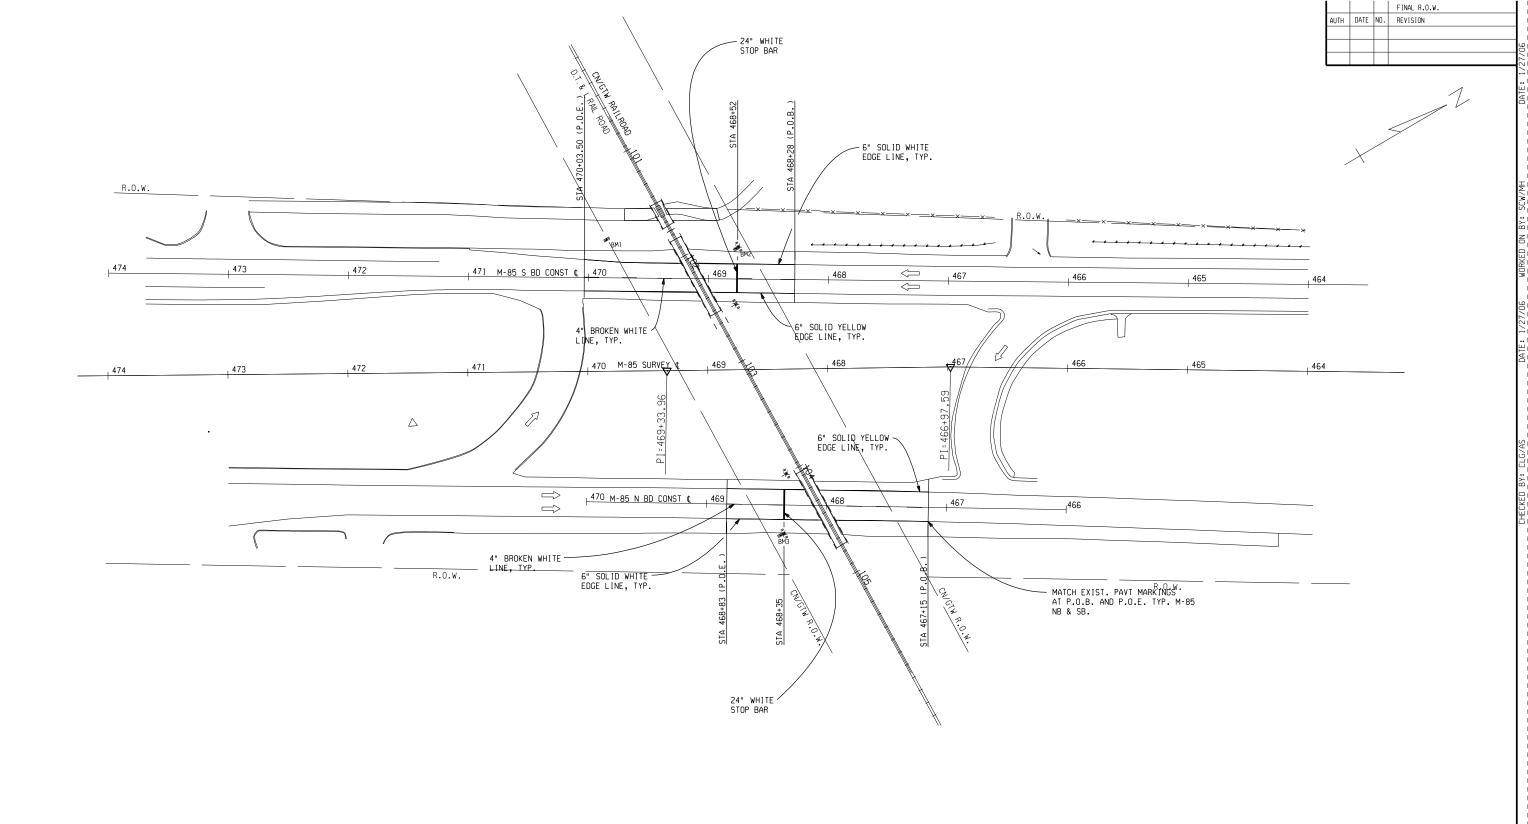

NOTE:
THE CONTRACTOR SHALL LOG EXISTING PERMANENT PAVEMENT
MARKINGS TO BE REMOVED FOR MAINTAINING TRAFFIC AND
RESTORE THEM IN-KIND AS DIRECTED BY THE ENGINEER
INCLUDED IN PAYMENT FOR PERMANENT PAVEMENT MARKING
PAY ITEMS.


PERMANENT PAVEMENT MARKING SHEET




M-85 AT GO1 OF 82211, CN/GTW RAILROAD CROSSING

 DATE
 SCALE
 CONT. SEC.
 JOB NO.
 DESIGN UNIT
 SHEET NO.

 03/10/06
 1" = 40'
 82211
 73160A
 YUNG
 R.O.W CONST.

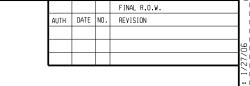


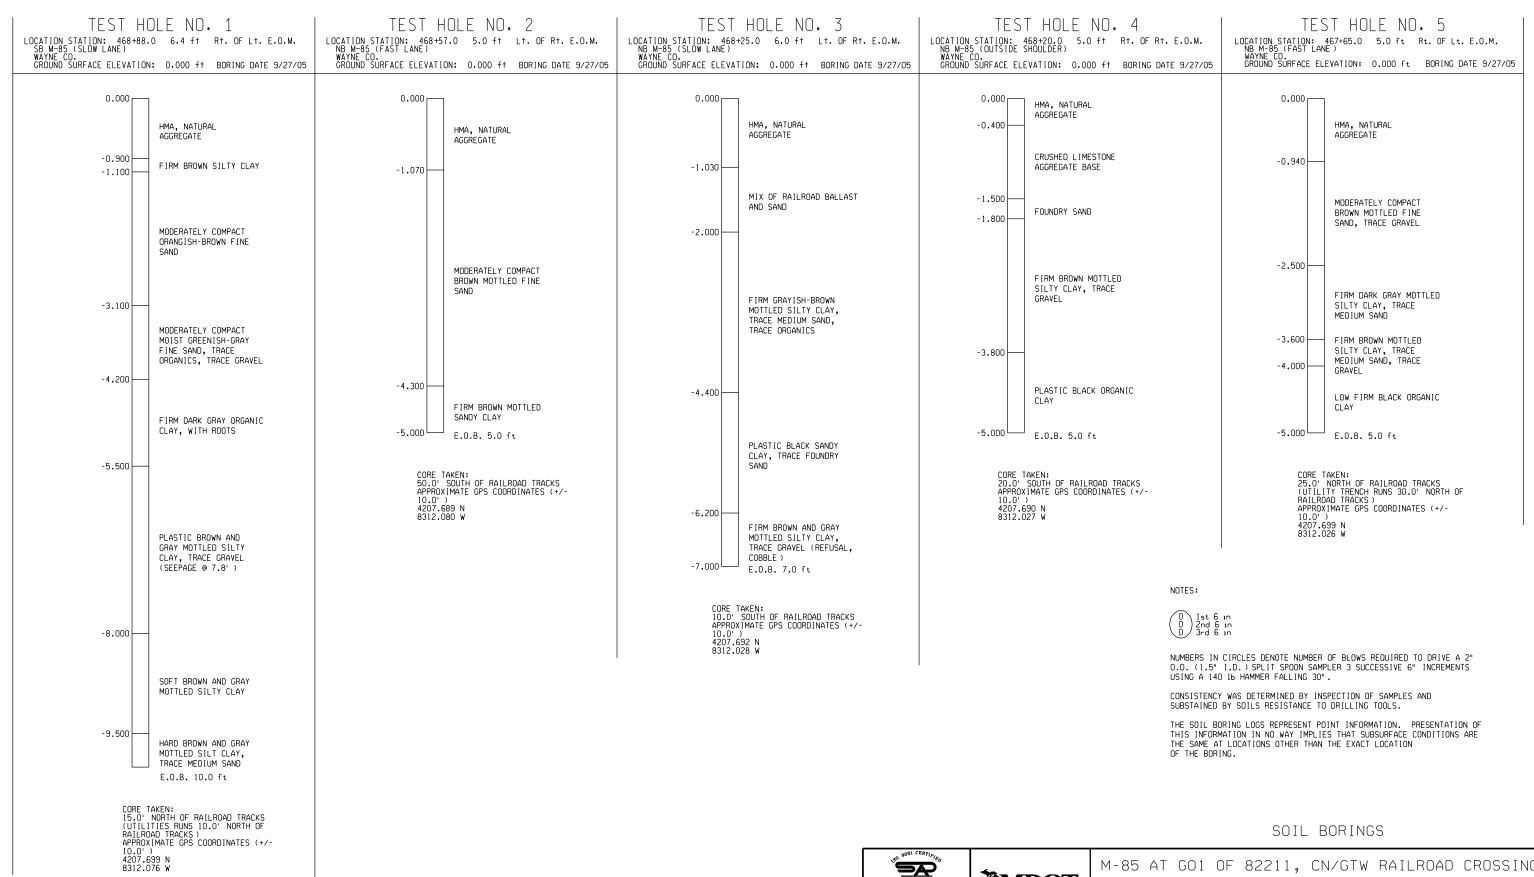





	M-85	ΑT	GO1	OF	82211,	CN/GTW	RAILROAD	CROSSING
--	------	----	-----	----	--------	--------	----------	----------

DATE	SCALE	CONT. SEC.	JOB NO.	DESIGN UNIT	SHEET NO.
					R.O.W CONS
03/10/06		82211	73160A	YUNG	22

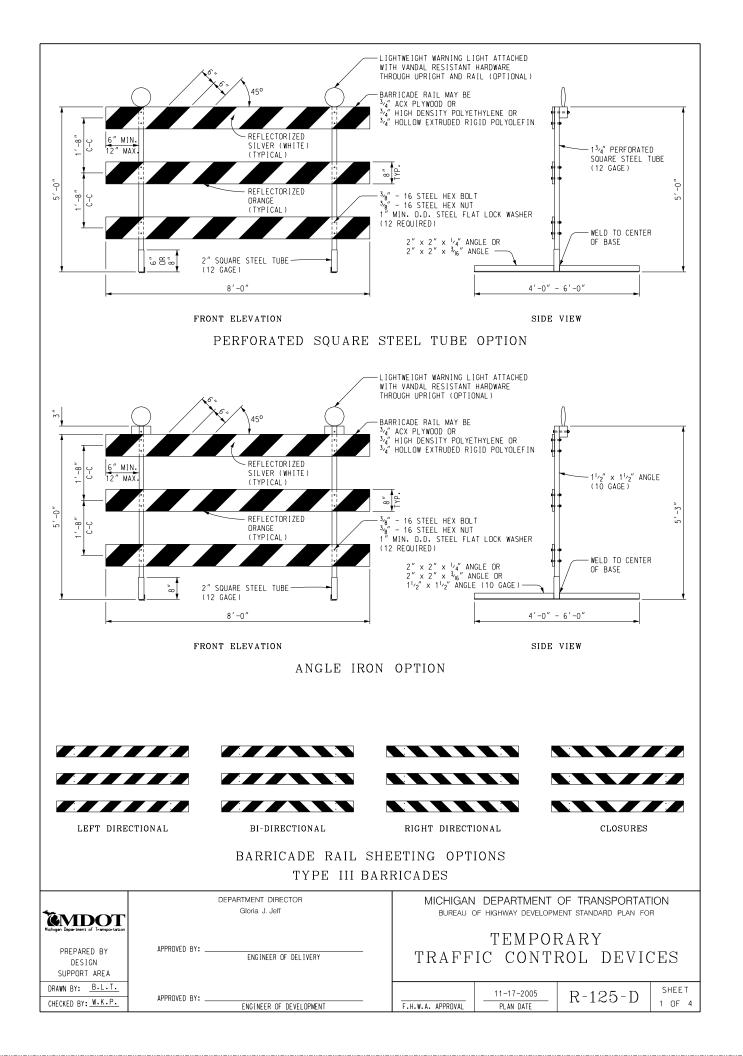


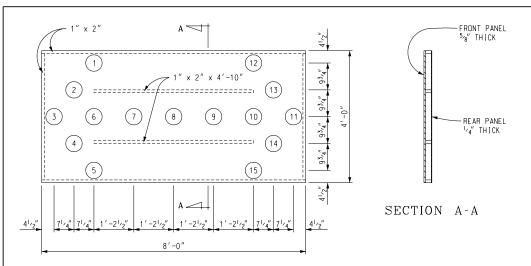

LIGHTED ARROW TYPE C

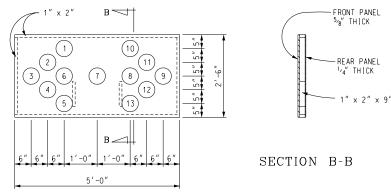



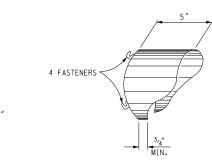

NOTE:

A STANDARD 6" DIAMETER CUTAWAY VISOR, SIMILAR TO THE ONE SHOWN, SHALL BE MOUNTED OVER EACH LIGHT. THE ARC ENCLOSED BY THE VISOR SHALL BE A MINIMUM OF 290 DEGREES. THE VISOR SHALL BE OF SHEET CONSTRUCTION AND OF NON-FERROUS, CORROSION-RESISTANT MATERIAL WITH A MINIMUM THICKNESS OF 0.045". IT SHALL BE PAINTED FLAT BLACK INSIDE AND OUT. THE AXIS OF THE VISOR SHALL BE PERPENDICULAR TO THE PANEL.

VISOR


OPERATION MODES USE LIGHTS AS FOLLOWS					
LIGHTED ARROW	LEFT ARROW	RIGHT ARROW	LEFT-RIGHT ARROW	BAR	
TYPE C	1, 2, 3, 4, 5, 7, 8, 9, 10, & 11 (10 BULBS)	3, 6, 7, 8, 9, 11, 12, 13, 14, & 15 (10 BULBS)	ALL EXCEPT 6 & 10 (13 BULBS)	** 3,7.8, 9, & 11 (5 BULBS)	
TYPE B	1, 2, 3, 4, 5, 6, 7, 8, & 9 (9 BULBS)	3, 6, 7, 8, 9, 10, 11, 12, & 13 (9 BULBS)	ALL (13 BULBS)	3, 6, 7, 8, & 9 (5 BULBS)	

^{**} BULBS 6 & 10 ARE OPTIONAL IN THE BAR MODE OF THE LIGHTED ARROW-TYPE C.

MICHIGAN DEPARTMENT OF TRANSPORTATION
BUREAU OF HIGHWAY DEVELOPMENT STANDARD PLAN FOR

TEMPORARY
TRAFFIC CONTROL DEVICES

F.H.W.A. APPROVAL	11-17-2005 PLAN DATE	R-125-D	SHEET 2 OF 4
	CONTROL 82211	^{J0B} 73160A	SHEET N

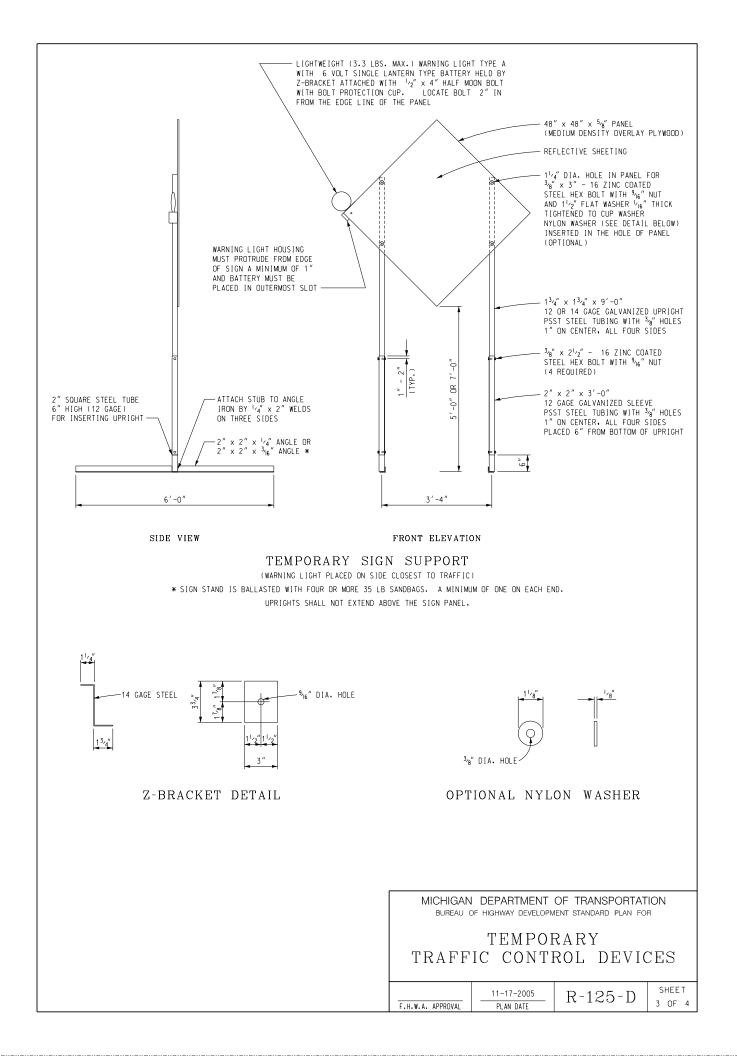


PLASTIC DRUM

▲ ▲ PROPOSED TYPE III BARRICADE

A A EXISTING TYPE III BARRICADE

SYMBOLS TO BE USED ON PLANS

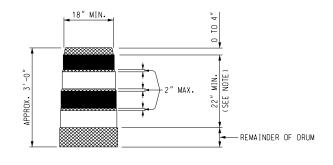

REFLECTORIZED ORANGE

___ REFLECTORIZED WHITE

NON REFLECTORIZED ORANGE

DRUMS SHALL HAVE AT LEAST 4 HORIZONTAL REFLECTORIZED STRIPES (2 ORANGE AND 2 WHITE) OF 4" TO 6" UNIFORM WIDTH, ALTERNATING IN COLOR WITH THE TOPMOST REFLECTORIZED STRIPE BEING ORANGE, NON REFLECTORIZED SPACES BETWEEN THE HORIZONTAL REFLECTORIZED ORANGE AND WHITE STRIPES SHALL BE ORANGE IN COLOR AND EQUAL IN WIDTH.

PLASTIC DRUM

NOTES:

2" PERFORATED SQUARE STEEL TUBES MAY BE USED TO FABRICATE THE HORIZONTAL BASE OF THE TYPE III BARICADE.

WARNING LIGHTS SHALL BE PLACED ACCORDING TO THE CURRENT STANDARD SPECIFICATIONS WHEN THEY ARE USED ON PLASTIC DRUMS OR TYPE !!!

SEE STANDARD PLANS R-113-SERIES AND R-126-SERIES FOR TYPICAL LOCATION AND SPACING OF PLASTIC DRUMS.

SIGNS, BARRICADES, AND PLASTIC DRUMS SHALL BE FACED WITH PRESSURE-SENSITIVE REFLECTIVE SHEETING ACCORDING TO THE CURRENT STANDARD SPECIFICATIONS.

SANDBAGS SHALL BE USED WHEN SUPPLEMENTAL WEIGHTS ARE REQUIRED TO ACHIEVE STABILITY OF THE BARRICADE. THE SANDBAGS SHALL BE PLACED SO THEY WILL NOT COVER OR OBSTRUCT ANY REFLECTIVE PORTION OF THE TRAFFIC CONTROL DEVICE.

A SEQUENTIAL ARROW IS NOT ALLOWED. (THE WHOLE ARROW MUST GO ON AND OFF AT THE SAME TIME.)

MICHIGAN DEPARTMENT OF TRANSPORTATION BUREAU OF HIGHWAY DEVELOPMENT STANDARD PLAN FOR

TEMPORARY TRAFFIC CONTROL DEVICES

SHEET 11-17-2005 R-125-D 4 OF 4 F.H.W.A. APPROVAL PLAN DATE SHEET NO. CONTROL 82211 JOB 73160A 24